

**CAPITAL IMPROVEMENT PLANS FOR  
McQUEENEY ROAD  
PAVEMENT REHABILITATION PROJECT  
IH 35 N TO W COUNTY LINE RD  
NEW BRAUNFELS, TX 78130**

CONTRACT: NB 24-088




OWNER: CITY OF NEW BRAUNFELS  
550 LANDA ST  
NEW BRAUNFELS, TX 78140

ENGINEER: VICKREY & ASSOCIATES, LLC.  
12940 COUNTRY PARKWAY SAN ANTONIO, TEXAS 78216  
(210) 349-3271  
FIRM REGISTRATION #F-159

NOTES:

- A. ALL RESPONSIBILITY FOR THE ADEQUACY OF THESE PLANS REMAINS WITH THE ENGINEER OF RECORD. IN ACCEPTING THESE PLANS, THE NEW BRAUNFELS MUST RELY UPON THE ADEQUACY OF THE WORK OF THE ENGINEER OF RECORD.
- B. IF CONSTRUCTION HAS NOT COMMENCED WITHIN ONE-YEAR OF CITY APPROVAL FOR CONSTRUCTION INSPECTION, THAT APPROVAL IS NO LONGER VALID.
- C. TYPE 3 DEVELOPMENT.
- D. FEMA DEFINED FLOOD HAZARD AREA IN WHICH THE PROJECT IS LOCATED WITH THE EFFECTIVE FIRM PANEL 48091C0465G DATED 5/8/2024.
- E. PROJECT LOCATION DOES NOT FALL WITHIN EDWARDS AQUIFER AUTHORITY JURISDICTIONAL ZONE.

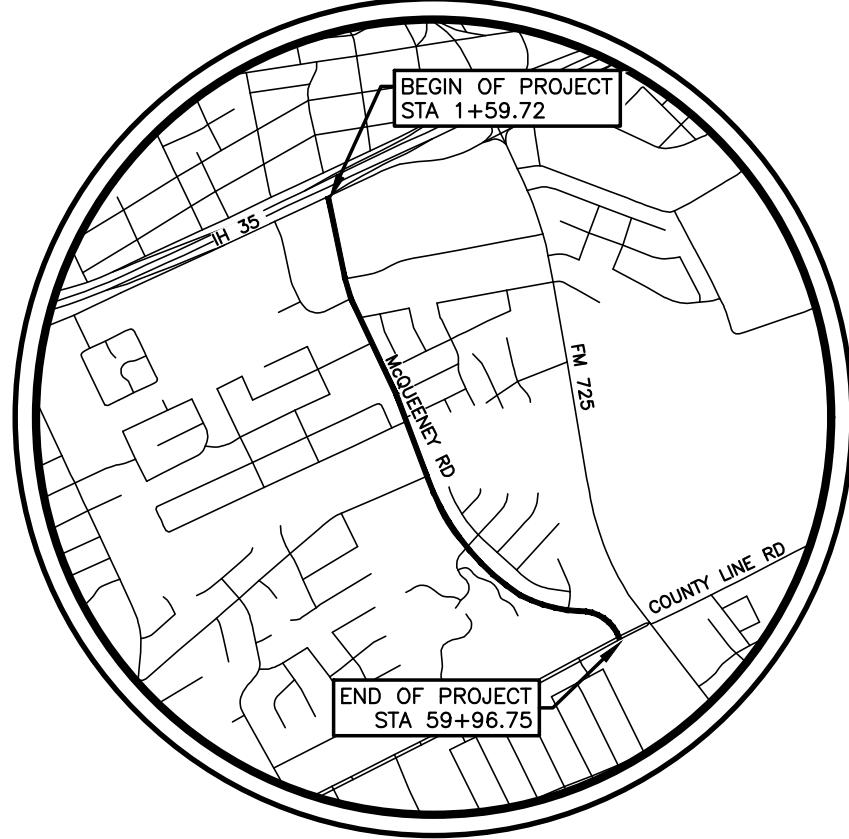

## LOCATION MAP

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**VICKREY & ASSOCIATES, LLC.  
CONSULTING ENGINEERS**

12940 COUNTRY PARKWAY  
SAN ANTONIO, TX 78216  
TELEPHONE: (210) 349-3271  
FIRM REGISTRATION NO: F-15

**TEXAS ACCESSIBILITY STANDARD REVIEW**  
**TO BE COORDINATED BY:**  
**THE CITY OF NEW BRAUNFELS**

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\* THE STANDARD SHEETS SPECIFICALLY IDENTIFIED (\*) ABOVE HAVE BEEN SELECTED BY ME OR UNDER MY RESPONSIBLE SUPERVISION AS BEING APPLICABLE TO THIS PROJECT.

*Paul A. Schroeder* 07-09-2024  
PAUL A. SCHROEDER, PE, RPLS

**COVER SHEET**

MCQUEENEY ROAD REHABILITATION PROJECT  
IH 35 N TO W COUNTY LINE RD  
NEW BRAUNFELS, TEXAS 78130

DRAWN BY: MPC/SMH  
CHECKED BY: PAS  
APPROVED BY: --  
SHEET OF  
1 29  
PROJ. NO. 23-00251

CITY OF NEW BRAUNFELS  
GENERAL NOTES  
FOR CAPITAL IMPROVEMENTS

GENERAL:

- ALL WORK SHALL BE DONE IN ACCORDANCE WITH THE TXDOT STANDARD SPECIFICATIONS FOR CONSTRUCTION AND MAINTENANCE OF HIGHWAYS, STREETS AND BRIDGES (2014), CITY OF SAN ANTONIO STANDARD SPECIFICATIONS, AND THE CITY OF NEW BRAUNFELS STANDARDS AS APPLICABLE. A COPY OF THE CONTRACT DOCUMENTS, PLANS AND SPECIFICATIONS SHALL BE MAINTAINED BY THE CONTRACTOR ON-SITE AT ALL TIMES.
- ALL WORK ON THIS PROJECT SHALL BE PERFORMED IN ACCORDANCE WITH ALL APPLICABLE FEDERAL, STATE, AND LOCAL LAWS, REGULATIONS, AND ORDINANCES. CONTRACTOR SHALL OBTAIN ALL PERMITS AND INSPECTIONS REQUIRED TO COMPLETE THE WORK WITH NO ADDITIONAL COMPENSATION.
- THE CONTRACTOR SHALL PROVIDE THE CITY AN EMERGENCY TELEPHONE NUMBER FOR EVENINGS, WEEKENDS, AND HOLIDAYS BY THE FIRST WORKING DAY FOR THE PROJECT. THE CONTRACTOR SHALL RESPOND TO THE CITY STAFF WITHIN TWO HOURS OF THE INITIAL CONTACT.
- CONTRACTOR'S PERSONNEL SHALL WEAR IDENTIFYING CLOTHING OR HATS AT ALL TIMES DURING WORKING HOURS.
- ALL EXISTING UTILITIES SHALL BE FIELD VERIFIED AND PROTECTED BY THE CONTRACTOR PRIOR TO THE START OF CONSTRUCTION. THE CONTRACTOR SHALL COMPLY WITH TEXAS EXCAVATION LAWS AND CONTACT TEXAS-811 72 HOURS PRIOR TO DOING ANY WORK IN THE AREA. CONTRACTOR SHALL COORDINATE ALL WORK WITH ADJACENT UTILITIES IN THE AREA INCLUDING BUT NOT LIMITED TO: CENTERPOINT (GAS), NBU ELECTRIC, NBU WATER, AT&T TELEPHONE CO., TIME WARNER CABLE, NEW BRAUNFELS PUBLIC WORKS DEPARTMENT, NEW BRAUNFELS FIRE ADMINISTRATION.
- CONTRACTOR SHALL PRESERVE ALL SURVEY MONUMENTATION AND SITE MARKINGS PROVIDED. CONTRACTOR SHALL BE RESPONSIBLE FOR ALL CONSTRUCTION STAKING REQUIRED FOR THE SUCCESSFUL COMPLETION OF THE PROJECT.
- CONTRACTOR IS REQUIRED TO VERIFY PROJECT ELEVATIONS. THE TERM "MATCH EXISTING" SHALL BE UNDERSTOOD TO SIGNIFY BOTH HORIZONTAL AND VERTICAL ALIGNMENT.
- CONTRACTOR IS REQUIRED TO PREPARE A CONSTRUCTION PHASING PLAN DETAILING LIMITS OF CONSTRUCTION FOR EACH PHASE. PHASING PLAN MUST BE SUBMITTED TO THE CITY FOR APPROVAL PRIOR TO CONSTRUCTION. CONTRACTOR WILL NOT BE ALLOWED TO WORK OUT OF PHASE UNLESS WRITTEN APPROVAL HAS BEEN OBTAINED FROM THE CITY FOR THE PHASE CHANGE. THIS PLAN MUST INCLUDE TRAFFIC CONTROLS FOR EACH CONSTRUCTION PHASE.
- THE INTENT OF THE CONSTRUCTION DOCUMENTS IS TO DESCRIBE THE WORK AND MATERIALS REQUIRED FOR THE PROJECT. THE CONTRACTOR IS RESPONSIBLE FOR ALL SUBSIDIARY WORK AND MEANS AND METHODS NECESSARY TO COMPLETE THE PROJECT.
- CONTRACTOR SHALL PROVIDE WRITTEN NOTIFICATION TO THE OWNER AND DESIGN ENGINEER OF DISCREPANCIES BETWEEN THE CONSTRUCTION DRAWINGS AND SPECIFICATIONS. THE MORE STRINGENT REQUIREMENTS SHALL GOVERN UNLESS OTHERWISE DIRECTED IN WRITING BY THE OWNER.
- CONTRACTOR SHALL PROVIDE WRITTEN NOTIFICATION TO THE OWNER AND DESIGN ENGINEER OF DISCREPANCIES BETWEEN THE SITE CONDITIONS AND THESE CONSTRUCTION DOCUMENTS PRIOR TO CONSTRUCTION. CONTRACTOR SHALL ASSUME FULL RESPONSIBILITY FOR ALL NECESSARY REVISIONS DUE TO FAILURE TO GIVE SUCH NOTIFICATION.

SITE:

- CONTRACTOR AGREES TO ASSUME SOLE AND COMPLETE RESPONSIBILITY FOR JOB SITE CONDITIONS DURING THE CONSTRUCTION OF THE PROJECT, INCLUDING THE SECURITY AND SAFETY OF ALL PERSONS AND PROPERTY; THAT THIS REQUIREMENT SHALL APPLY CONTINUOUSLY AND NOT BE LIMITED TO NORMAL WORKING HOURS; AND THAT THE CONTRACTOR SHALL DEFEND, INDEMNIFY AND HOLD THE OWNERS AND THE ENGINEER AND HIS EMPLOYEES, PARTNERS, OFFICERS, DIRECTORS, OR CONSULTANTS, HARMLESS FROM ANY AND ALL LIABILITY, REAL OR ALLEGED, IN CONNECTION WITH THE PERFORMANCE OF THE WORK ON THIS PROJECT, EXCEPTING FROM LIABILITY ARISING FROM SOLE NEGLIGENCE OF THE OWNER OR ENGINEER, ENGINEER'S DIRECTORS, OFFICERS, EMPLOYEES, OR CONSULTANTS.
- CONTRACTOR SHALL INSTALL AND MAINTAIN PROJECT SIGN IN ACCORDANCE WITH CITY STANDARDS AND SPECIFICATIONS
- ANY ITEMS REQUESTED BY THE OWNER TO BE SALVAGED SHALL BE REMOVED, PROTECTED AND RELOCATED OR REINSTALLED AS DIRECTED BY THE OWNER.
- THE CONTRACTOR IS RESPONSIBLE FOR REPAIRING ANY DAMAGE CAUSED BY THE CONTRACTOR OUTSIDE OF THE DESIGNATED WORK AREA. ANY EXISTING OFF-SITE IMPROVEMENTS THAT ARE DAMAGED OR UNDERCUT BY THE CONTRACTOR'S OPERATIONS SHALL BE REPAIRED OR REPLACED AS DIRECTED BY THE ENGINEER AND APPROVED BY THE OWNER OF THE EXISTING IMPROVEMENTS AT THE CONTRACTOR'S EXPENSE. (NO SEPARATE PAY)
- CONTRACTOR IS RESPONSIBLE FOR REMOVAL OF ALL WASTE MATERIALS. THE LOCATION FOR THE DISPOSAL OF CONSTRUCTION MATERIAL WITHIN THE CITY LIMITS SHALL BE APPROVED BY THE CITY OF NEW BRAUNFELS PRIOR TO THE START OF CONSTRUCTION. THE CONTRACTOR SHALL NOT PLACE ANY WASTE MATERIAL IN THE 100-YEAR FLOOD PLAIN WITHOUT FIRST OBTAINING AN APPROVED FLOOD PLAIN DEVELOPMENT PERMIT.
- CONTRACTOR IS RESPONSIBLE FOR BEST MANAGEMENT PRACTICES REGARDING DUST, DIRT AND EROSION CONTROL. THE STREET PAVEMENT, ADJACENT DRIVEWAYS, SIDEWALKS, AND WALKWAYS SHALL BE SWEEP FREE OF MUD AND ALL DEBRIS REMOVED FROM THE WORK AREA DAILY.
- ALL AREAS ADJACENT TO CONSTRUCTION AREAS MUST BE SAFE FOR PEDESTRIAN TRAFFIC BEFORE, DURING, AND AFTER CONSTRUCTION.

EROSION CONTROL:

- THE CONTRACTOR IS REQUIRED BY THE FEDERAL CLEAN WATER ACT, USEPA REGULATIONS, TPDES AND NPDES GENERAL PERMIT TO DEVELOP A SITE SPECIFIC STORM WATER POLLUTION PROTECTION PLAN (SWPPP) FOR THE PROJECT WHICH INCLUDES ALL DISTURBED AREAS BY THE CONSTRUCTION INCLUDING BORROW, STAGING AND STORAGE AREAS AND TO SECURE A PERMIT FROM TCEQ. THE SWPPP WITH REQUIRED INSPECTION REPORTS MUST BE KEPT UP TO DATE AND KEPT ON THE CONSTRUCTION SITE AT ALL TIMES. THE CONTRACTOR MUST PREPARE A NOTICE OF INTENT (NOI) AND SECURE A PERMIT FROM TCEQ FOR LARGE CONSTRUCTION SITES OF 5 OR MORE ACRES OF DISTURBED AREA WITH A COPY OF THE NOI AND THE REQUIRED CONSTRUCTION SITE NOTICE POSTED AT THE CONSTRUCTION ENTRANCE IN CLEAR VIEW OF THE PUBLIC DURING THE CONSTRUCTION. FOR LARGE CONSTRUCTION SITES AFTER THE SITE IS 70% OR GREATER STABILIZED SO THAT THERE IS NO FURTHER DANGER OF EROSION AND SEDIMENTATION POLLUTION FROM THE SITE DISTURBED AREAS, THE CONTRACTOR MUST PREPARE AND SUBMIT A NOTICE OF TERMINATION (NOT) TO TCEQ. A COPY OF THE NOI AND NOT MUST BE SUBMITTED TO THE CITY ENGINEER FOR EACH PERMITTED PROJECT. SEE STATE REGULATIONS GENERAL PERMIT TO DISCHARGE WASTE UNDER THE TEXAS POLLUTION DISCHARGE ELIMINATION SYSTEM (TPDES) NO. TX 150000.
- PROVIDE A COPY OF ANY REQUIRED SW3P TO THE CITY PRIOR TO BEGINNING CONSTRUCTION.
- ALL EROSION CONTROL MEASURES SHALL BE IN PLACE PRIOR TO ANY CONSTRUCTION ACTIVITIES. THE EROSION CONTROL MEASURES SHALL REMAIN IN PLACE AND FUNCTIONAL UNTIL AFTER THE PROPOSED IMPROVEMENTS ARE IN PLACE AND VEGETATION IS ESTABLISHED. THE CONTRACTOR HAS THE ULTIMATE RESPONSIBILITY FOR THE EFFECTIVE CONTROL OF EROSION AND SEDIMENTATION.
- ADJUSTMENTS AND REPAIRS TO THE EROSION CONTROL DEVICES SHALL BE MADE AS NEEDED AT CONTRACTOR'S EXPENSE.
- SEED/SOD SHALL BE FURNISHED TO ESTABLISH GROUND COVER OVER ALL DISTURBED AREAS AS REQUIRED BY THE CONTRACT DOCUMENTS. THE CONTRACTOR SHALL NOT WAIT UNTIL COMPLETION OF THE ENTIRE PROJECT BEFORE DOING THIS WORK. THE PROJECT SHALL NOT BE CONSIDERED FOR ACCEPTANCE BY THE CITY UNLESS THE ESTABLISHMENT OF 80% GROUND COVER IS ENSURED.

TRAFFIC:

- IT IS THE CONTRACTOR'S SOLE RESPONSIBILITY TO SEE THAT ALL TRAFFIC CONTROL DEVICES ARE PROPERLY INSTALLED AND MAINTAINED AT THE JOB SITE IN ACCORDANCE WITH THE PLANS, SPECIFICATIONS AND RELATED INDUSTRY STANDARDS AND REGULATIONS. THESE NOTES, DO NOT, IN AND OF THEMSELVES, CONSTITUTE A TRAFFIC CONTROL PLAN. IN THE EVENT THAT THESE PLANS DO NOT INCLUDE TRAFFIC CONTROL, OR THAT THE CONTRACTOR WISHES TO VARY FROM TRAFFIC CONTROL INCLUDED WITH THESE PLANS, HE SHALL SUBMIT A TRAFFIC CONTROL PLAN SEALED BY A PROFESSIONAL ENGINEER REGISTERED IN THE STATE OF TEXAS, FOR REVIEW AND APPROVAL BY THE CITY PRIOR TO CONSTRUCTION. PLAN SHALL INCLUDE SIGN AND BARRICADE PLAN CONFORMING TO THE REQUIREMENTS OF THE TEXAS MANUAL ON UNIFORM TRAFFIC CONTROL DEVICES. THE CITY'S CONSTRUCTION INSPECTOR AND THE TRAFFIC ENGINEERING REPRESENTATIVE WILL ONLY BE RESPONSIBLE TO INSPECT THE TRAFFIC CONTROL DEVICES BEING DEPLOYED. IF, IN THE OPINION OF THE TRAFFIC ENGINEERING REPRESENTATIVE AND/OR THE CONSTRUCTION INSPECTOR, THE TRAFFIC CONTROL DEVICES DO NOT CONFORM TO ESTABLISHED STANDARDS OR ARE INCORRECTLY PLACED OR ARE INSUFFICIENT IN QUANTITY TO PROTECT THE GENERAL PUBLIC, THE INSPECTOR SHALL HAVE THE OPTION TO STOP CONSTRUCTION OPERATIONS AT NO EXPENSE TO THE CITY UNTIL SUCH TIME AS THE CONDITIONS ARE CORRECTED BY THE CONTRACTOR.
- ALL TRAFFIC CONTROL DEVICES, PLACEMENT AND ACTIVITIES SHALL BE AS PER THE LATEST EDITION OF THE TEXAS MANUAL OF

- UNIFORM TRAFFIC CONTROL DEVICES (TXMUTCD). IF THERE IS ANY CONFLICT BETWEEN THE TXMUTCD AND TRAFFIC CONTROL REQUIREMENTS WITHIN THE CONTRACT DOCUMENTS, THE CONTRACTOR SHALL NOTIFY THE ENGINEER IMMEDIATELY.
- THE CONTRACTOR SHALL PROVIDE PROPER BARRICADES AND MAINTAIN TRAFFIC FLOW AS PER THE TEXAS MANUAL ON UNIFORM TRAFFIC CONTROL DEVICES (TXMUTCD) AT ALL TIMES.
- AS WORK PROGRESSES, LOCATION OF TEMPORARY TRAFFIC CONTROL DEVICES WILL BE ADJUSTED AND MODIFIED, AS NECESSARY BY THE CONTRACTOR AT THE CONTRACTOR'S EXPENSE.
- THE CONTRACTOR SHALL NOTIFY THE TEXAS DEPARTMENT OF TRANSPORTATION PRIOR TO WORKING AT THE INTERSECTION OF ANY STATE OWNED OR MAINTAINED ROADWAY.
- FOR STREETS LISTED ON THE CITY OF NEW BRAUNFELS MAJOR THOROUGHFARE PLAN AND ALL ROAD CLOSURE REQUESTS, THE CONTRACTOR SHALL SUBMIT AND OBTAIN APPROVAL OF AN ENGINEERED TRAFFIC CONTROL PLAN AND WORK SCHEDULE TO THE CITY FOR APPROVAL TWO WEEKS PRIOR TO COMMENCING WORK.
- WORK AROUND SCHOOLS SHALL BE SCHEDULED TO ELIMINATE IMPACTS TO THE SCHOOL. LANES SHALL NOT BE CLOSED DURING THE TIME STUDENTS ARE BEING DROPPED OFF AND PICKED UP FROM SCHOOL. WORK WITHIN A SCHOOL ZONE CAN ONLY OCCUR BETWEEN THE HOURS OF 9 AM AND 2 PM.
- THE CONTRACTOR SHALL MAINTAIN THE FLOW OF TRAFFIC AT ALL TIMES AND PROVIDE ACCESS FOR THE DELIVERY OF MAIL BY THE U.S. POSTAL SERVICE, AND COLLECTION OF GARBAGE WHETHER PUBLIC OR PRIVATE.
- CONTRACTOR SHALL MAINTAIN ACCESS TO ALL COMMERCIAL AND RESIDENTIAL DRIVEWAYS AT ALL TIMES. CONTRACTOR SHALL PROVIDE 48 HOUR MINIMUM NOTICE TO PROPERTY OWNERS AND THE CITY PRIOR TO ANY MODIFICATION TO DRIVEWAY ACCESS.
- DURING ASPHALT OVERLAY, THE CONTRACTOR SHALL ALLOW RESIDENT TRAFFIC ACCESS TO THE STREET WITH PROPER GUIDANCE, DIRECTION, FLAGMEN AND TRAFFIC CONTROL AND ONLY AT SUCH TIME THAT DAMAGE WILL NOT OCCUR TO THE NEW ASPHALT OVERLAY OR TO THE VEHICLES.

UTILITIES:

- THE EXISTENCE AND LOCATION OF UNDERGROUND UTILITIES INDICATED ON THE PLANS ARE TAKEN FROM AVAILABLE RECORDS AND ARE NOT GUARANTEED. THE LOCATION AND DEPTH OF EXISTING UTILITIES ARE APPROXIMATE ONLY AND SHALL BE INVESTIGATED AND VERIFIED BY THE CONTRACTOR BEFORE STARTING WORK. CONTRACTOR SHALL BE HELD RESPONSIBLE FOR ANY DAMAGE TO AND FOR THE MAINTENANCE AND PROTECTION OF THE EXISTING UTILITIES WHETHER SHOWN OR NOT ON THE PLANS INCLUDING BUT NOT LIMITED TO EXISTING WATER, SANITARY SEWER, GAS, STORM SEWERS, ELECTRIC AND TELECOMMUNICATION LINES AND SERVICES.
- IN THE EVENT OF DAMAGE TO UNDERGROUND FACILITIES, WHETHER SHOWN OR NOT IN THE DRAWINGS. THE CONTRACTOR SHALL MAKE NECESSARY REPAIRS TO RESTORE THE FACILITY BACK IN SERVICE AND AT NO COST TO THE OWNER. REPAIRS SHALL CONFORM TO THE REQUIREMENTS OF THE UTILITY OR AGENCY SERVICING THE FACILITY.
- CONTRACTOR SHALL COORDINATE WITH AND GAIN APPROVAL FROM THE UTILITY COMPANY OWNING THE FACILITY PRIOR TO RELOCATION OR ADJUSTMENT AS REQUIRED FOR CONFORMANCE TO PROJECT ALIGNMENT OR GRADES. ADJUSTMENT OF ALL EXISTING MANHOLES, THAT REMAIN IN SERVICE, TO PROJECT GRADES SHALL BE THE CONTRACTOR'S RESPONSIBILITY.
- OSHA REGULATIONS PROHIBIT OPERATIONS THAT WILL BRING PERSONS OR EQUIPMENT WITHIN 10 FEET OF AN ENERGIZED LINE. WHERE WORKMEN AND/OR EQUIPMENT HAVE TO WORK CLOSE TO AN ENERGIZED ELECTRICAL LINE, THE CONTRACTOR SHALL NOTIFY THE ELECTRICAL POWER COMPANY INVOLVED AND MAKE WHATEVER ADJUSTMENTS NECESSARY TO ENSURE THE SAFETY OF THOSE WORKMEN.
- DU TO FEDERAL REGULATIONS TITLE 49, PART 192 [8], GAS COMPANIES MUST MAINTAIN ACCESS TO GAS VALVES AT ALL TIMES. THE CONTRACTOR MUST PROTECT AND WORK AROUND ANY GAS VALVES THAT ARE IN THE PROJECT AREA.
- THE CONTRACTOR WILL ABIDE BY ALL APPLICABLE FEDERAL, STATE, AND LOCAL LAWS GOVERNING EXCAVATION. TRENCH SIDE SLOPES SHALL MEET OCCUPATIONAL SAFETY AND HEALTH ADMINISTRATION (OSHA) STANDARDS IN EFFECT AT THE TIME OF CONSTRUCTION. SHEETING, SHORING AND BRACING SHALL BE REQUIRED IF SIDE SLOPE STANDARDS ARE NOT MET. THE CONTRACTOR SHALL PROVIDE DETAILED PLANS AND SPECIFICATIONS FOR TRENCH SAFETY SYSTEMS THAT MEET CURRENT OSHA STANDARDS FOR TRENCH EXCAVATIONS THAT EXCEED A DEPTH OF FIVE (5) FEET. PLANS MUST BE SEALED BY AN ENGINEER LICENSED BY THE STATE OF TEXAS AND SUBMITTED PRIOR TO BEGINNING CONSTRUCTION.
- CONTRACTOR AND/OR CONTRACTOR'S INDEPENDENTLY RETAINED EMPLOYEE OR SAFETY CONSULTANT SHALL IMPLEMENT A TRENCH SAFETY PROGRAM IN ACCORDANCE WITH OSHA STANDARDS GOVERNING THE PRESENCE AND ACTIVITIES OF INDIVIDUALS WORKING IN AND AROUND TRENCH EXCAVATION.
- ALL UTILITY TRENCH FILL MATERIAL SHALL BE PLACED IN UNIFORM LAYERS NOT TO EXCEED TWELVE INCHES (12") LOOSE. EACH LAYER OF MATERIAL SHALL BE COMPAKTED TO 95% DENSITY, ± 2% OPTIMUM MOISTURE AS DETERMINED BY TEST METHODS TEX-113-E, TEX-114-E, TEX-115-E. DENSITY TESTS SHALL BE TAKEN AT A MINIMUM OF 100 L.F. INTERVALS FOR EACH LIFT AS DETERMINED BY THE CITY INSPECTOR.
- CONTRACTOR SHALL NOTIFY THE CITY INSPECTOR FORTY EIGHT (48) HOURS PRIOR TO THE BACKFILL OF ANY UTILITY TRENCHES TO SCHEDULE DENSITY TESTS AS REQUIRED.

TREE PROTECTION:

- NO UTILITY OR STREET EXCAVATION WORK SHALL BEGIN IN AREAS WHERE TREE PRESERVATION AND TREATMENT MEASURES HAVE NOT BEEN COMPLETED AND APPROVED.
- TREE PROTECTION FENCING SHALL BE REQUIRED AND TREE PROTECTION FENCING SHALL BE INSTALLED, MAINTAINED AND REPAIRED BY THE CONTRACTOR DURING SITE CONSTRUCTION.
- EXPOSED ROOTS SHALL BE COVERED AT THE END OF THE DAY USING TECHNIQUES SUCH AS COVERING WITH SOIL, MULCH OR A ROOT PROTECTION ZONE WILL BE ESTABLISHED AROUND EACH TREE OR ANY VEGETATION TO BE PRESERVED. A ROOT PROTECTION ZONE SHALL BE AN AREA DEFINED BY THE RADIUS EXTENDING OUTWARD FROM THE TRUNK OF TREE A DISTANCE OF ONE (1) FOOT PER DIAMETER INCH OF THE TREE RADIUS AT BREAST HEIGHT (4.5"). AS AN EXAMPLE, A 10-INCH DIAMETER TREE WOULD HAVE A 10-FOOT RADIUS ROOT PROTECTION ZONE AROUND THE TREE.
- NO EQUIPMENT, VEHICLES OR MATERIALS SHALL OPERATE OR BE STORED WITHIN THE ROOT PROTECTION ZONE OF ANY TREE NEAR THE PROJECT. NO CLEAN-OUT AREAS SHALL BE CONSTRUCTED SO THAT THE MATERIAL WILL BE IN OR ADJACENT TO THE ROOT PROTECTION ZONE.
- ROOTS OR BRANCHES IN CONFLICT WITH THE CONSTRUCTION (INCLUDING MEETING TEXAS ACCESSIBILITY STANDARD (TAS) VERTICAL CLEARANCE REQUIREMENTS) SHALL BE CUT CLEANLY ACCORDING TO PROPER PRUNING METHODS. ALL OAK WOUNDS SHALL BE PAINTED OVER WITHIN 30 MINUTES TO PREVENT OAK WILT. NO SEPARATE PAY WILL BE MADE FOR TRIMMING TO MEET THESE REQUIREMENTS BUT WILL BE CONSIDERED SUBSIDARY TO THE VARIOUS BID ITEMS.
- TREES MUST BE MAINTAINED IN GOOD HEALTH THROUGHOUT THE CONSTRUCTION PROCESS. MAINTENANCE MAY INCLUDE WATERING THE ROOT PROTECTION ZONE AND OR WASHING FOLIAGE.
- NO WIRES, NAILS OR OTHER MATERIALS MAY BE ATTACHED TO THE PROTECTED TREES.
- TREES, WHICH ARE DAMAGED OR LOST DUE TO THE CONTRACTOR'S NEGLIGENCE DURING CONSTRUCTION, SHALL BE MITIGATED TO THE CITY'S SATISFACTION.
- TREES, TREE LIMBS, BUSHES AND SHRUBS LOCATED IN THE CITY STREET OR ALLEY RIGHT-OF-WAY OR PERMANENT EASEMENTS WHICH INTERFERE WITH THE PROPOSED CONSTRUCTION ACTIVITIES MAY BE NEATLY TRIMMED BY THE CONTRACTOR ONLY AFTER APPROVAL FROM THE CITY INSPECTOR. THERE SHALL BE NO SEPARATE PAY FOR ADDITIONAL COST OR EFFORT INCURRED BY THE CONTRACTOR WHERE REQUIRED TO WORK AROUND AND/OR UNDER EXISTING TREES OR FOR THE REMOVAL ADDITIONAL BRANCHES & SHRUBS.
- SAPLINGS, SHRUBS OR BUSHES TO BE CLEARED FROM THE PROTECTED ROOT ZONE AREA OF A LARGE TREE SHALL BE REMOVED BY HAND AS DESIGNATED BY THE CITY STREET INSPECTOR.
- CONTRACTOR TO PROTECT ALL TREES WITHIN THE PROJECT LIMITS AND TREES OUTSIDE THE PROJECT LIMITS THAT MAY BE IMPACTED BY THE PROJECT.

ROADWAY :

- ALL ROADWAY COMPAKCTION TESTS SHALL BE COORDINATED WITH THE CITY INSPECTOR. FLEXIBLE BASE OR FILL MATERIAL SHALL BE PLACED IN UNIFORM LAYERS NOT TO EXCEED SIX-INCHES (6") COMPAKCTED. EACH LAYER OF MATERIAL, INCLUSIVE OF SUBGRADE, SHALL BE COMPAKCTED AS SPECIFIED AND TESTED FOR DENSITY AND MOISTURE IN ACCORDANCE WITH TEST METHODS TEX-113-E, TEX-114-E, TEX-115-E. THE NUMBER AND LOCATION OF REQUIRED TESTS SHALL BE DETERMINED BY THE GEO-TECHNICAL ENGINEER AND APPROVED BY THE CITY OF NEW BRAUNFELS STREET INSPECTOR. AT A MINIMUM, TESTS SHALL BE TAKEN EVERY 100LF FOR EACH LIFT. UPON COMPLETION OF TESTING THE GEO-TECHNICAL ENGINEER WILL PROVIDE THE CITY OF NEW BRAUNFELS STREET INSPECTOR WITH ALL TESTING DOCUMENTATION AND A CERTIFICATION STATING THAT THE PLACEMENT OF FLEXIBLE BASE, AND FILL MATERIAL, AND SUBGRADE, HAS BEEN COMPLETED IN ACCORDANCE WITH THE PLANS.
- CONTRACTOR SHALL PROVIDE 48 HOUR MINIMUM NOTICE TO THE CITY INSPECTOR PRIOR TO ANY WORK REQUIRING MATERIAL TESTING.
- ASPHALTIC CONCRETE PAVEMENT SHALL BE TYPE "D" AND TYPE "B" HOT MIX ASPHALT AS DEFINED IN TXDOT'S STANDARD SPECIFICATIONS FOR TXDOT STANDARD SPECIFICATIONS FOR CONSTRUCTION OF HIGHWAYS, STREET AND BRIDGES, 2014.

- THE CITY OF NEW BRAUNFELS WILL NOT ACCEPT THE USE OF RECYCLED ASPHALT PAVEMENT (RAP) OR RECYCLED ASPHALT SHINGLES (RAS) IN ASPHALT MIXTURES FOR NEW ROADWAYS. ANY DEBRIS INCLUSIONS WITHIN NEW ASPHALT PAVEMENTS WILL RESULT IN ASPHALT REMOVAL AND REPLACEMENT FROM CURB TO CURB FOR LIMITS TO BE DETERMINED BY THE CITY OF NEW BRAUNFELS.
- THE ASPHALTIC CONCRETE SURFACE COURSE SHALL BE PLANT MIXED, HOT LAID TYPE "D" AND TYPE "B" MEETING THE SPECIFICATION REQUIREMENTS OF 2014 TXDOT ITEM 340. THE MIX SHALL BE DESIGNED FOR A STABILITY OF AT LEAST 35 AND SHALL BE COMPACTED TO BETWEEN 91 AND 95 PERCENT OF THE MAXIMUM THEORETICAL DENSITY AS DETERMINED BY TXDOT TEST METHOD TEX-227-F. THE ASPHALT CEMENT CONTENT BY PERCENT OF TOTAL MIXTURE WEIGHT SHALL FALL WITHIN A TOLERANCE OF +0.5 PERCENT FROM A SPECIFIC MIX DESIGN.
- A TXDOT TYPE II B-B BLUE REFLECTIVE RAISED PAVEMENT MARKER SHALL BE INSTALLED IN THE CENTER OF THE ROADWAY ADJACENT TO ALL FIRE HYDRANTS. IN LOCATIONS WHERE HYDRANTS ARE SITUATED ON CORNERS, BLUE REFLECTIVE RAISED PAVEMENT MARKERS SHALL BE INSTALLED ON BOTH APPROACHES WHICH FRONT THE HYDRANT. THE RAISED PAVEMENT MARKER SHALL MEET TXDOT MATERIAL, EPOXY AND ADHESIVE SPECIFICATIONS.
- ALL CONCRETE FOR FLATWORK INCLUDING CURB AND GUTTER, SIDEWALKS AND DRIVEWAYS SHALL BE CLASS A WITH A MINIMUM COMPRESSIVE STRENGTH OF 3,000PSI. MATERIAL TESTING METHODS AND FREQUENCY SHALL BE AS DESCRIBED IN ITEM 421 OF THE TXDOT STANDARD SPECIFICATIONS FOR CONSTRUCTION AND MAINTENANCE OF HIGHWAYS, STREETS AND BRIDGES.

GROUNDWATER:


- IT SHALL BE THE RESPONSIBILITY OF THE CONTRACTOR, SUBCONTRACTORS, BUILDERS, GEO-TECHNICAL ENGINEER, AND PROJECT ENGINEER TO IMMEDIATELY NOTIFY THE OFFICE OF THE CITY ENGINEER AND PROJECT ENGINEER IF THE PRESENCE OF GROUNDWATER WITHIN THE SITE IS EVIDENT. UPON NOTIFICATION THE PROJECT ENGINEER SHALL RESPOND WITH PLAN REVISIONS FOR THE MITIGATION OF THE GROUNDWATER ISSUE. THE CITY ENGINEER SHALL RESPOND WITHIN TWO (2) BUSINESS DAYS UPON RECEIPT OF THE MITIGATION PLAN. ALL CONSTRUCTION ACTIVITY, IMPACTED BY THE DISCOVERY OF GROUNDWATER, SHALL BE SUSPENDED UNTIL THE CITY ENGINEER GRANTS A WRITTEN APPROVAL OF THE GROUNDWATER MITIGATION PLAN.


  
PAUL A. SCHROEDER  
57564  
LICENSED  
PROFESSIONAL ENGINEER  
7/9/2024

  
VICKREY & ASSOCIATES, LLC.  
CONSULTING ENGINEERS  
1290 COUNTRY PARKWAY  
SAN ANTONIO, TX 78216  
TELEPHONE: (210) 349-3271  
FIRM REGISTRATION NO. F-159

GENERAL NOTES  
McQUEENEY ROAD REHABILITATION PROJECT  
IH 35 N TO W COUNTY LINE RD  
NEW BRAUNFELS, TEXAS 78130


DRAWN BY: MPC/SMH  
CHECKED BY: PAS  
APPROVED BY: ---  
SHEET 2 OF 29  
PROJ NO. 23-00251.DWG  
User: SHUETER Date: 07/29/2024

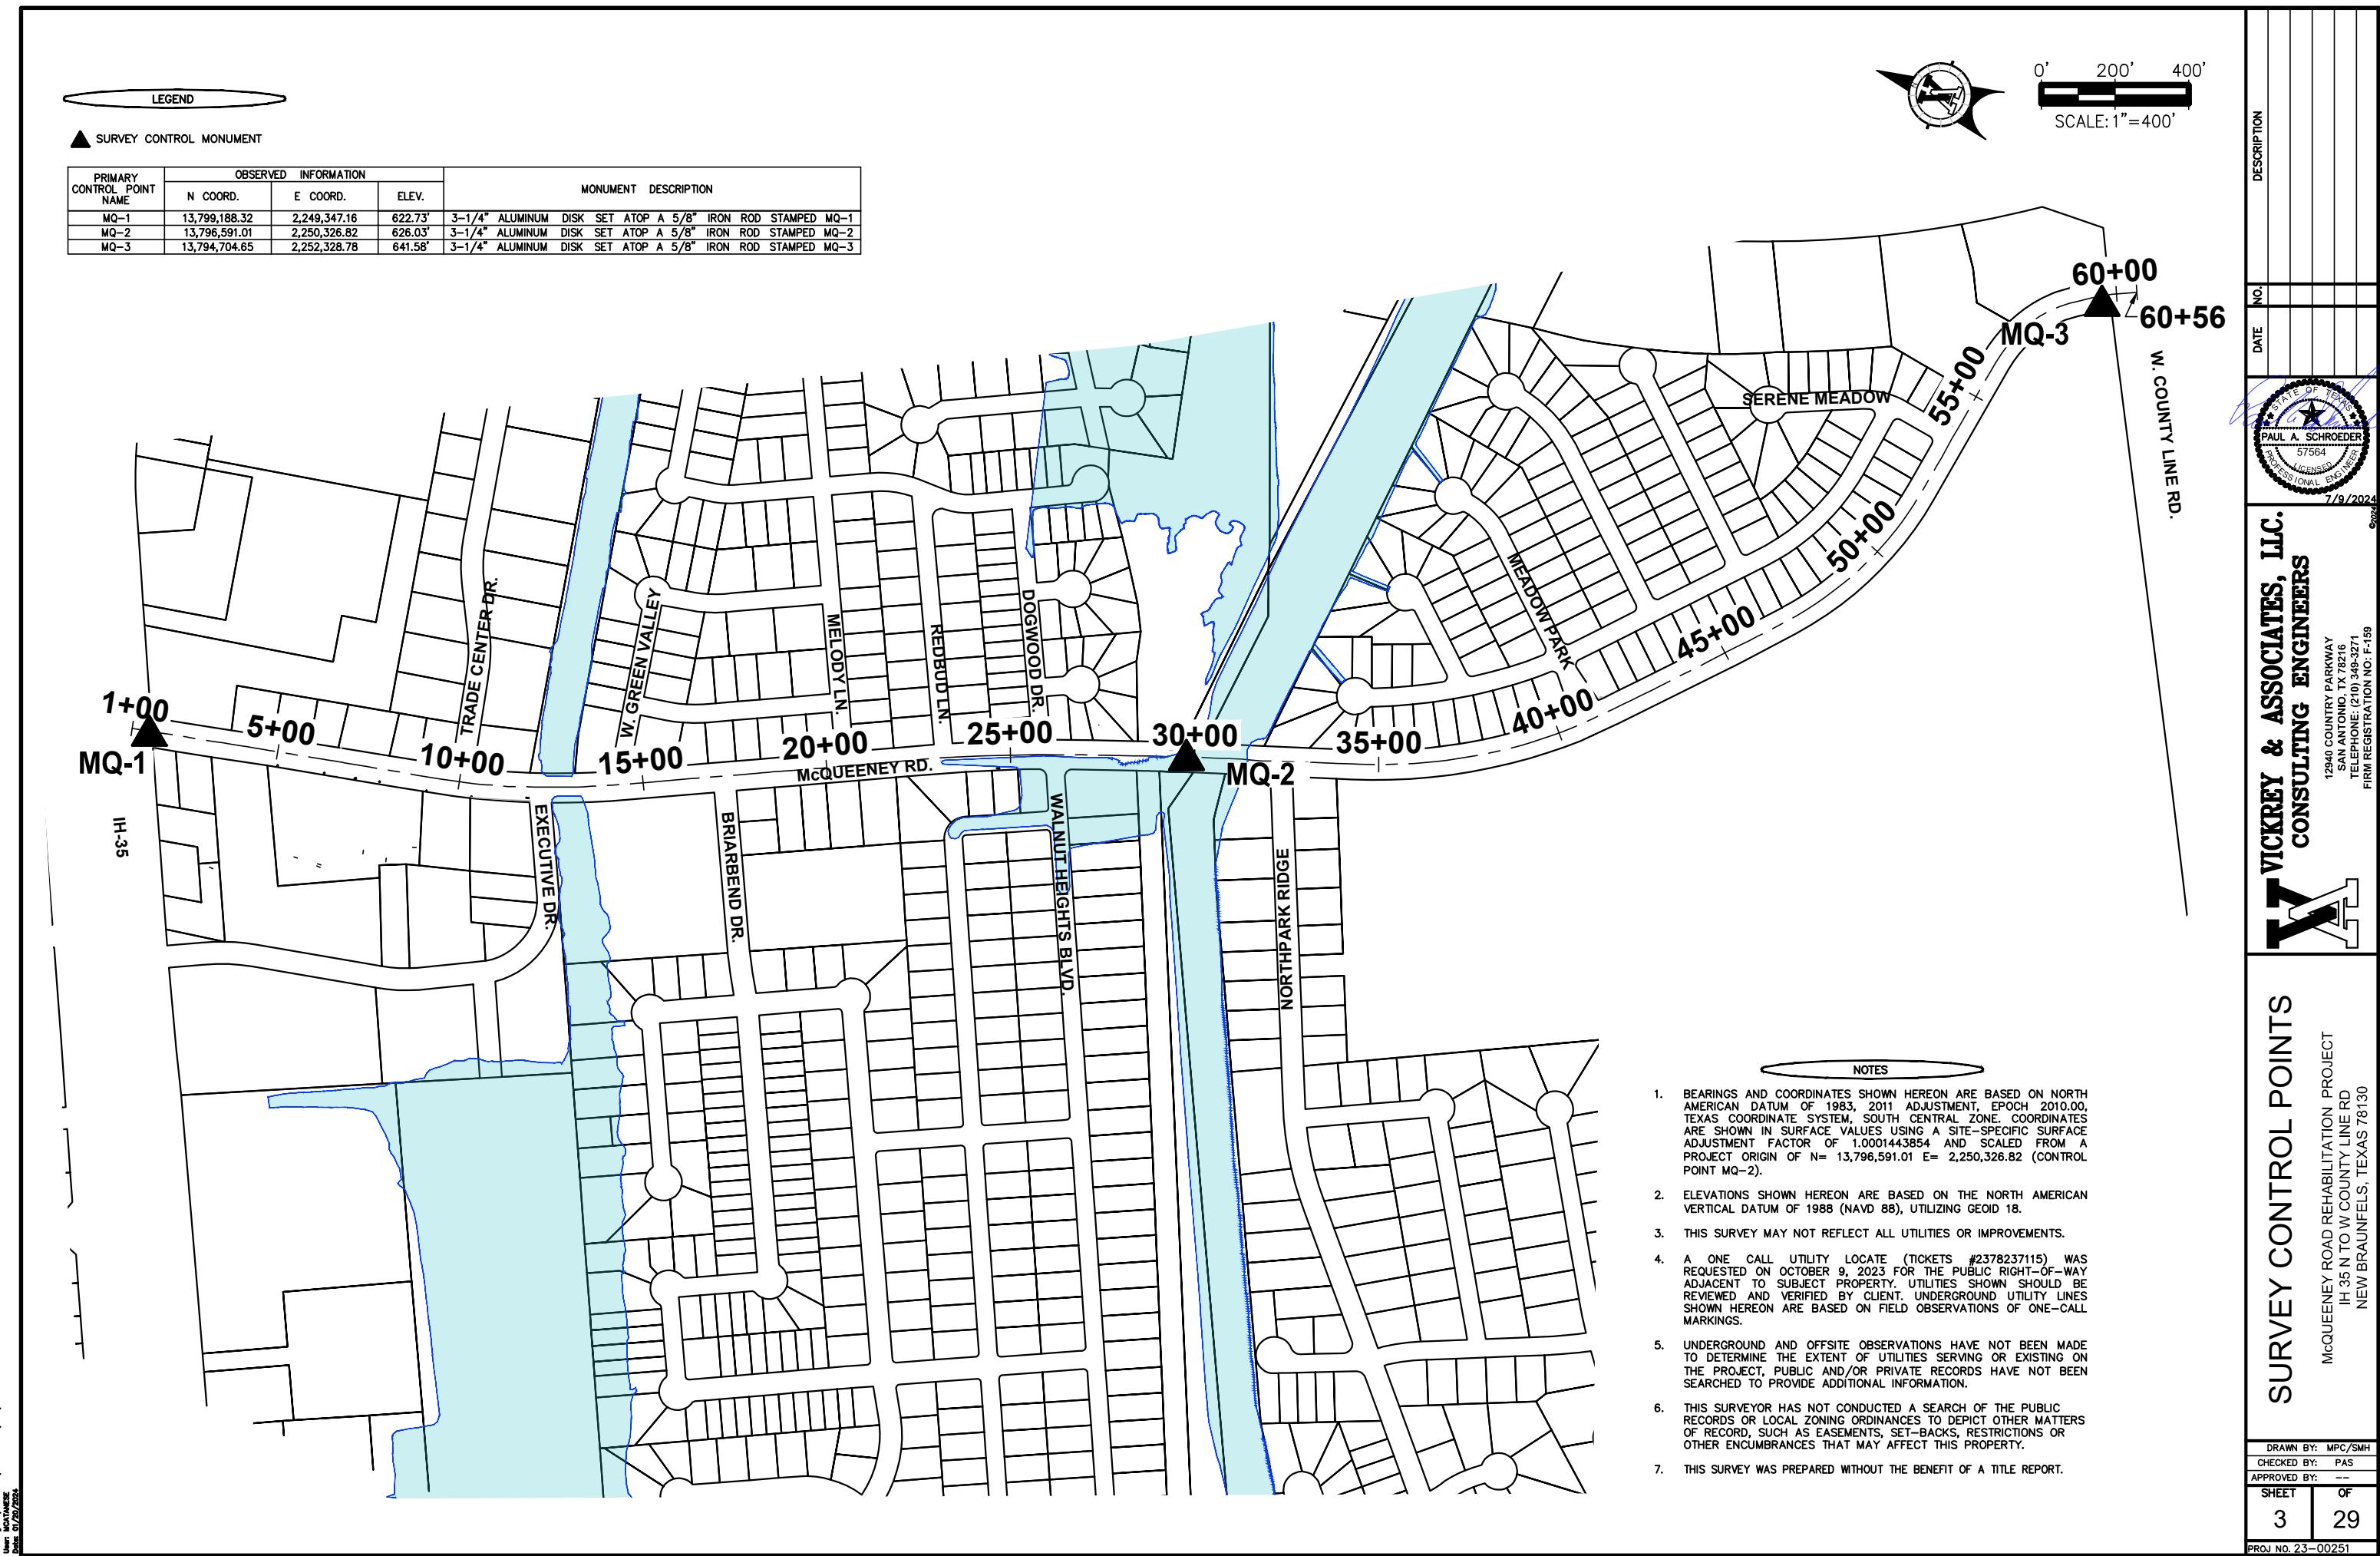

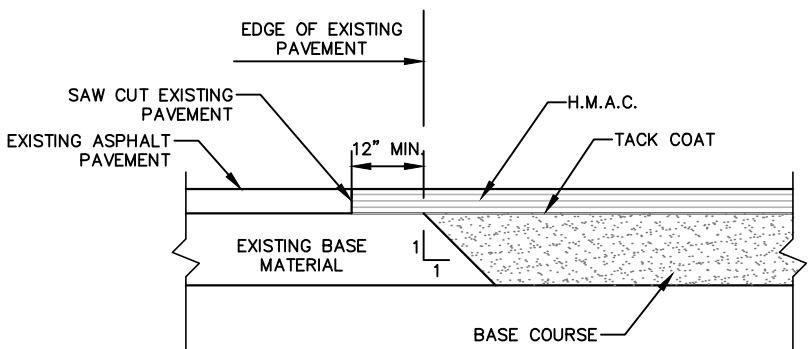


ASPHALT/ASPHALT JUNCTURE DETAIL

NOT-TO-SCALE

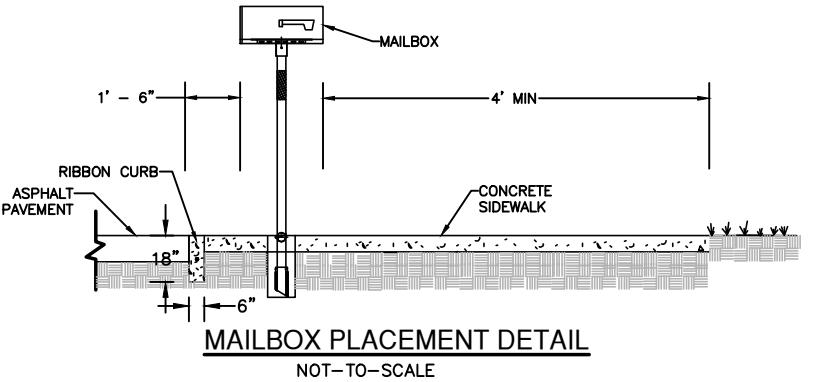


MAILBOX PLACEMENT DETAIL

NOT-TO-SCALE

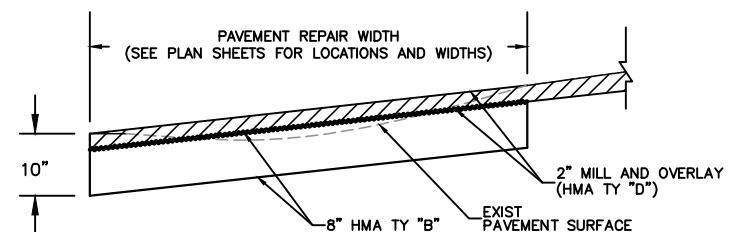

PAVEMENT REPLACEMENT DETAIL (FULL DEPTH)

NOT-TO-SCALE

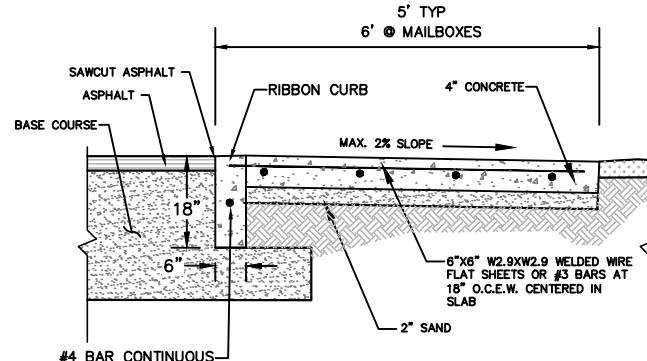


SIDEWALK DETAIL

NOT-TO-SCALE  
RIGHT OF CENTERLINE  
STA 1+69.57 TO STA 2+24.00  
STA 8+07.18 TO STA 10+48.31  
STA 13+43.24 TO STA 17+67.18

**VICKREY & ASSOCIATES, LLC.**  
CONSULTING ENGINEERS


12940 COUNTRY PARKWAY  
SAN ANTONIO, TX 78216  
TELEPHONE: (210) 349-3271  
FIRM REGISTRATION NO. F-159

McQUEENEY ROAD REHABILITATION PROJECT  
IH 35 N TOWNSHIP LINE RD  
NEW BRAUNFELS, TEXAS 78130

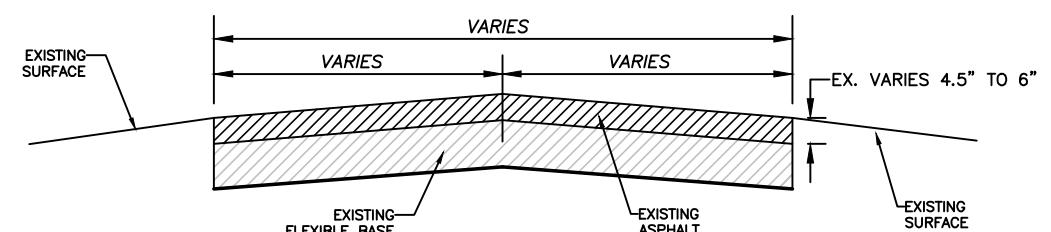


EXISTING ROAD TYPICAL SECTION

NOT-TO-SCALE

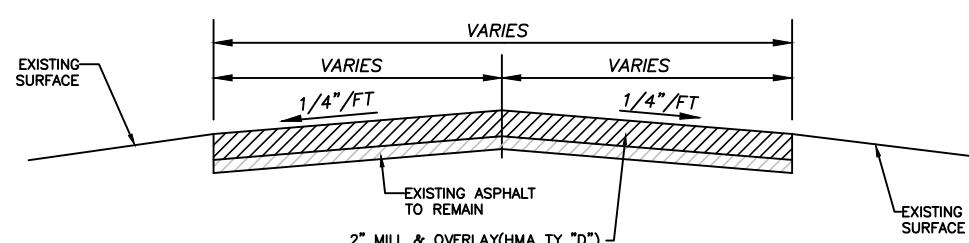

PROPOSED ROAD TYPICAL SECTION

NOT-TO-SCALE

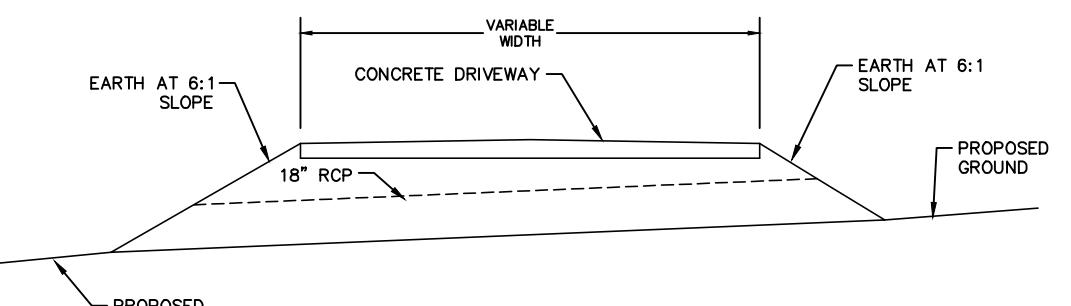

DRIVEWAY CULVERT TYPICAL SECTION

NOT-TO-SCALE

DRAWN BY: MPC/SMH  
CHECKED BY: PAS  
APPROVED BY: ---  
SHEET 4 OF 29  
PROJ. NO. 23-00251

ITEMS	ITEM DESCRIPTION	UNIT	QUANTITY
100-6001	PREPARING ROW	STA	58
104-6015*	REMOVING CONC (SIDEWALKS)	SY	51
104-6017	REMOVING CONC (DRIVeways)	SY	157
340-6272	TACK COAT	GAL	2647.8
341-6027	D-GR HMA TY-C SAC-B PG70-22	TON	1915.43
351-6004**	FLEXIBLE PAVEMENT STRUCTURE REPAIR (8")	SY	8348
354-6045	PLANING ASPH CONC PAV (2")	SY	9065
479-6001	ADJUSTING MANHOLES	EA	4
479-6005	ADJUSTING MANHOLES (WATER VALVE BOX)	EA	4
529-6001	CONC CURB (TY I)	LF	20
530-6004	DRIVeways (CONC)	SY	157
531-6001	CONC SIDEWALKS (4")	SY	573
531-6004	CURB RAMPS (TY 1)	EA	2
531-6006	CURB RAMPS (TY 3)	EA	2
531-6013	CURB RAMPS (TY 10)	EA	2
560-6001	MAILBOX INSTALL-S (TWG-POST) TY 1	EA	2
666-6174	REFL PAV MRK TY II (W) 6" (SLD)	LF	10740
666-6210	REFL PAV MRK TY II (Y) 6" (SLD)	LF	10166
672-6009	REFL PAV MRKR TY II-A-A	EA	128
666-6182	REFL PAV MRK TY II (W) 24" (SLD) (100 MIL)	LF	845
6001-6001	PORTABLE CHANGEABLE MESSAGE SIGN	DAY	60
160-6003	FURNISHING AND PLACING TOPSOIL (4")	SY	573.00
164-6029	CELL FBR MLCH SEED (TEMP) (WARM)	SY	573.00
168-6001	VEGETATIVE WATERING	MG	75.00
432-6001	RIPRAP (CONC) (4 IN)	CY	1.65
450-6047	RAIL (HANDRAIL) (TY A)	LF	25.00
506-6038	TEMP SEDMT CONT FENCE (INSTALL)	LF	238.00
SPECIAL	ELEVATED SIDEWALK	LF	12.00
SPECIAL	SPECIAL INLET GRATE	LS	1.00

NOTE	*INCLUDES ZEROSCAPE RESTORATION
NOTE	**INCLUDES REMOVAL AND DISPOSAL OF EXISTING MATERIAL.

## SUMMARY OF QUANTITIES

McQUEENEY ROAD REHABILITATION PROJECT  
IH 35 N TO W COUNTY LINE RD  
NEW BRAUNFELS, TEXAS 78130

**VICKREY & ASSOCIATES, LLC.**  
CONSULTING ENGINEERS

12940 COUNTRY PARKWAY  
SAN ANTONIO, TX 78216  
TELEPHONE: (210) 349-3271  
FIRM REGISTRATION NO.: F-159

DATE	NO.	DESCRIPTION
 PAUL A. SCHROEDER 57564 LICENSED PROFESSIONAL ENGINEER 7/9/2024		

DRAWN BY:	MPC/SMH
CHECKED BY:	PAS
APPROVED BY:	---
SHEET	OF
5	29

**TRAFFIC CONTROL & BARRICADE GENERAL NOTES**  
**SEQUENCE OF CONSTRUCTION & OPERATIONS**

INSTALL ALL BARRICADES, DETOURS & TEMP EROSION CONTROL MEASURES AS PER TXDOT STANDARDS PRIOR TO PHASING.

**PHASE I**

- PLACE TCP FOR CONSTRUCTION CONSIDERING DAILY FULL CLOSURES.
- ALL LANES TO BE OPEN NIGHTLY  
STA 14+00 TO 17+00 PERFORM FULL DEPTH REPAIR

**PHASE II**

- PLACE TCP FOR CONSTRUCTION, CONSIDERING DAILY LANE CLOSURES W/ FLAGGER CONTROLLED TWO-WAY TRAFFIC
- ALL LANES TO BE OPEN NIGHTLY
- STA 19+00 TO 21+00 PERFORM FULL DEPTH REPAIR

**PHASE III**

- PLACE TCP FOR CONSTRUCTION CONSIDERING DAILY LANE CLOSURES W/ FLAGGER CONTROLLED TWO-WAY TRAFFIC
- ALL LANES TO BE OPEN NIGHTLY
- STA 21+76 TO 27+65 PERFORM FULL DEPTH REPAIR

**PHASE IV**

- PLACE TCP FOR CONSTRUCTION CONSIDERING DAILY FULL CLOSURES W/ FLAGGER CONTROLLED TWO-WAY TRAFFIC
- ALL LANES TO BE OPEN NIGHTLY
- STA 37+00 TO 39+25 and 41+50 TO 44+75 EAST SIDE OF ROAD PERFORM FULL DEPTH REPAIR

**PHASE V**

- PLACE TCP FOR CONSTRUCTION CONSIDERING DAILY LANE CLOSURES W/ FLAGGER CONTROLLED TWO-WAY TRAFFIC
- ALL LANES TO BE OPEN NIGHTLY
- STA 37+00 TO 40+57 AND 41+50 TO 43+25 WEST SIDE OF ROAD PERFORM FULL DEPTH REPAIR

**PHASE VI**

- PLACE TCP FOR CONSTRUCTION CONSIDERING DAILY LANE CLOSURES W/ FLAGGER CONTROLLED TWO-WAY TRAFFIC
- ALL LANES TO BE OPEN NIGHTLY
- STA 50+52 TO 57+97 PERFORM FULL DEPTH REPAIR

**PHASE VII**

- PLACE TCP FOR CONSTRUCTION CONSIDERING TWO-WAY TRAFFIC CONTROLLED BY FLAGGER
- ALL LANES TO BE OPEN NIGHTLY
- STA 12+50 TO END PERFORM MILL & OVERLAY (REF PAVING PLAN FOR SECTIONS)

**PHASE VIII**

- PLACE TCP FOR CONSTRUCTION CONSIDERING MAINTAINING TWO-WAY TRAFFIC
- STA 1+63 TO END INSTALL CONCRETE SIDEWALKS

**TRAFFIC CONTROL & BARRICADE GENERAL NOTES**


- THE CONTRACTOR'S OPERATION SHALL BE SUCH THAT THE SAFETY OF THE TRAVELING PUBLIC SHALL BE OF PRIME IMPORTANCE. THE FOLLOWING SEQUENCE WAS DEVELOPED AS A GENERAL OUTLINE FOR A TCP PLAN. THE CONTRACTOR IS RESPONSIBLE FOR THE FINAL DEVELOPMENT AND DESIGN OF THE TCP.
- INSTALL ALL BARRICADES, SIGNS AND OTHER DEVICES AS SHOWN AND IN ACCORDANCE WITH THE TEXAS MUTCD, APPLICABLE TxDOT BARRICADE AND CONSTRUCTION STANDARDS, OR AS DIRECTED BY THE CITY OF NEW BRAUNFELS' ENGINEER, FOR ADDITIONAL INFORMATION SEE TYPICAL APPLICATIONS TA-6, TA-21, TA-22, TA-23, TA-24, TA-25, & TA-30 AS SHOWN IN THE TEXAS MUTCD.
- ADDITIONAL SIGNS, BARRICADES OR TRAFFIC CONTROL DEVICES OTHER THAN THOSE SPECIFIED MAY BE REQUIRED FOR THE SAFE MOVEMENT OF TRAFFIC THROUGH THE PROJECT. PAYMENT FOR ALL SUCH SIGNS, BARRICADES OR TRAFFIC CONTROL DEVICES SHALL BE CONSIDERED SUBSIDIARY TO THE ITEM 502, "BARRICADES, SIGNS AND TRAFFIC HANDLING."
- WORK SITES SHOULD BE CAREFULLY MONITORED TO ENSURE THAT TRAFFIC CONTROL MEASURES ARE OPERATING EFFECTIVELY AND THAT ALL DEVICES USED ARE CLEARLY VISIBLE, CLEAN, AND IN GOOD REPAIR.
- THE CONTRACTOR SHALL BE REQUIRED TO SUBMIT A DETAILED SCHEDULE OF WORK TO THE PROJECT ENGINEER PRIOR TO THE BEGINNING OF CONSTRUCTION.
- CONTRACTOR SHALL PROVIDE INGRESS AND EGRESS FOR ALL ADJACENT PROPERTY AT ALL TIMES.
- THE CONTRACTOR SHALL DEVELOP A TCP. ANY REQUEST TO ALTER THE SEQUENCE OF CONSTRUCTION OR TRAFFIC CONTROL PLAN SHALL BE SUBMITTED IN WRITING TO THE CITY OF NEW BRAUNFELS' ENGINEER FOR WRITTEN APPROVAL.
- THE ENGINEER WILL CONSIDER FULL LANE CLOSURE WITH AN APPROVED DETOUR PLAN.





**VICKREY & ASSOCIATES, LLC.**  
**CONSULTING ENGINEERS**

12940 COUNTRY PARKWAY  
 SAN ANTONIO, TX 78216  
 TELEPHONE: (210) 349-3271  
 FIRM REGISTRATION NO: F-159

**TRAFFIC CONTROL  
 NARRATIVE & DETAILS**  
 McQUEENEY ROAD REHABILITATION PROJECT  
 IH 35 N TO W COUNTY LINE RD  
 NEW BRAUNFELS, TEXAS 78130

DRAWN BY: MPC/SMH  
 CHECKED BY: PAS  
 APPROVED BY: --  
 SHEET 6 OF 29  
 PROJ NO. 23-00251

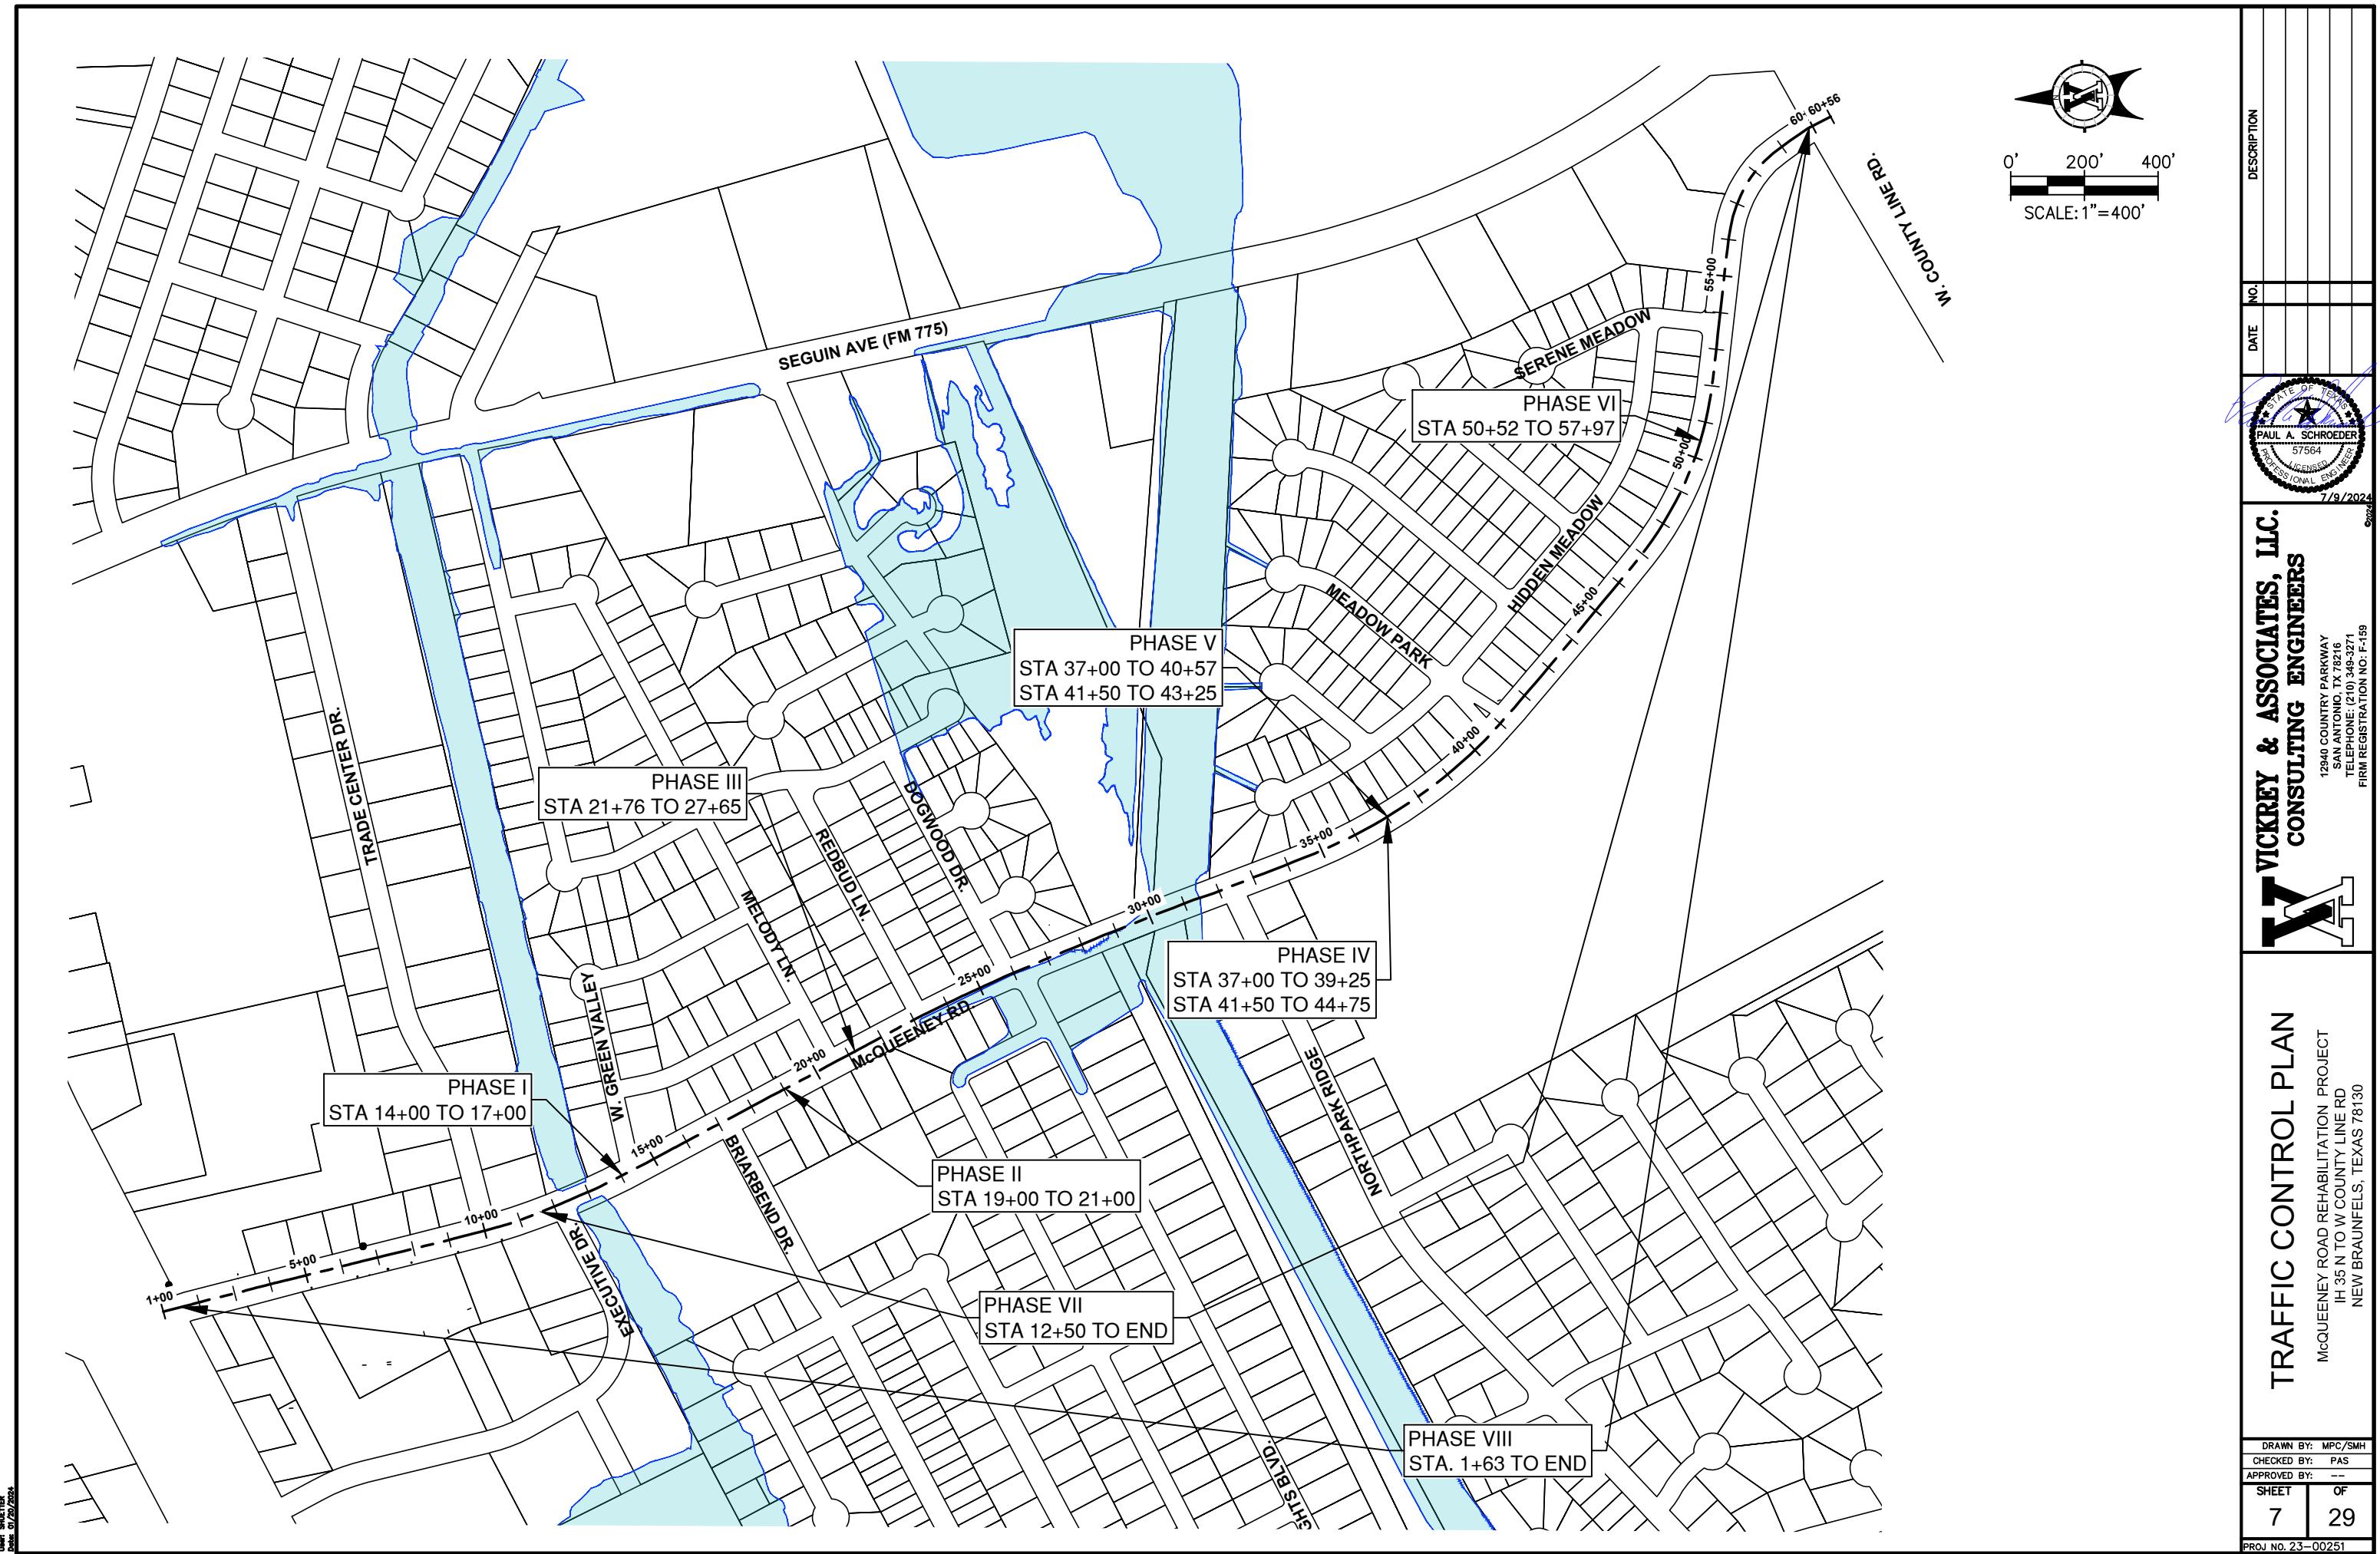

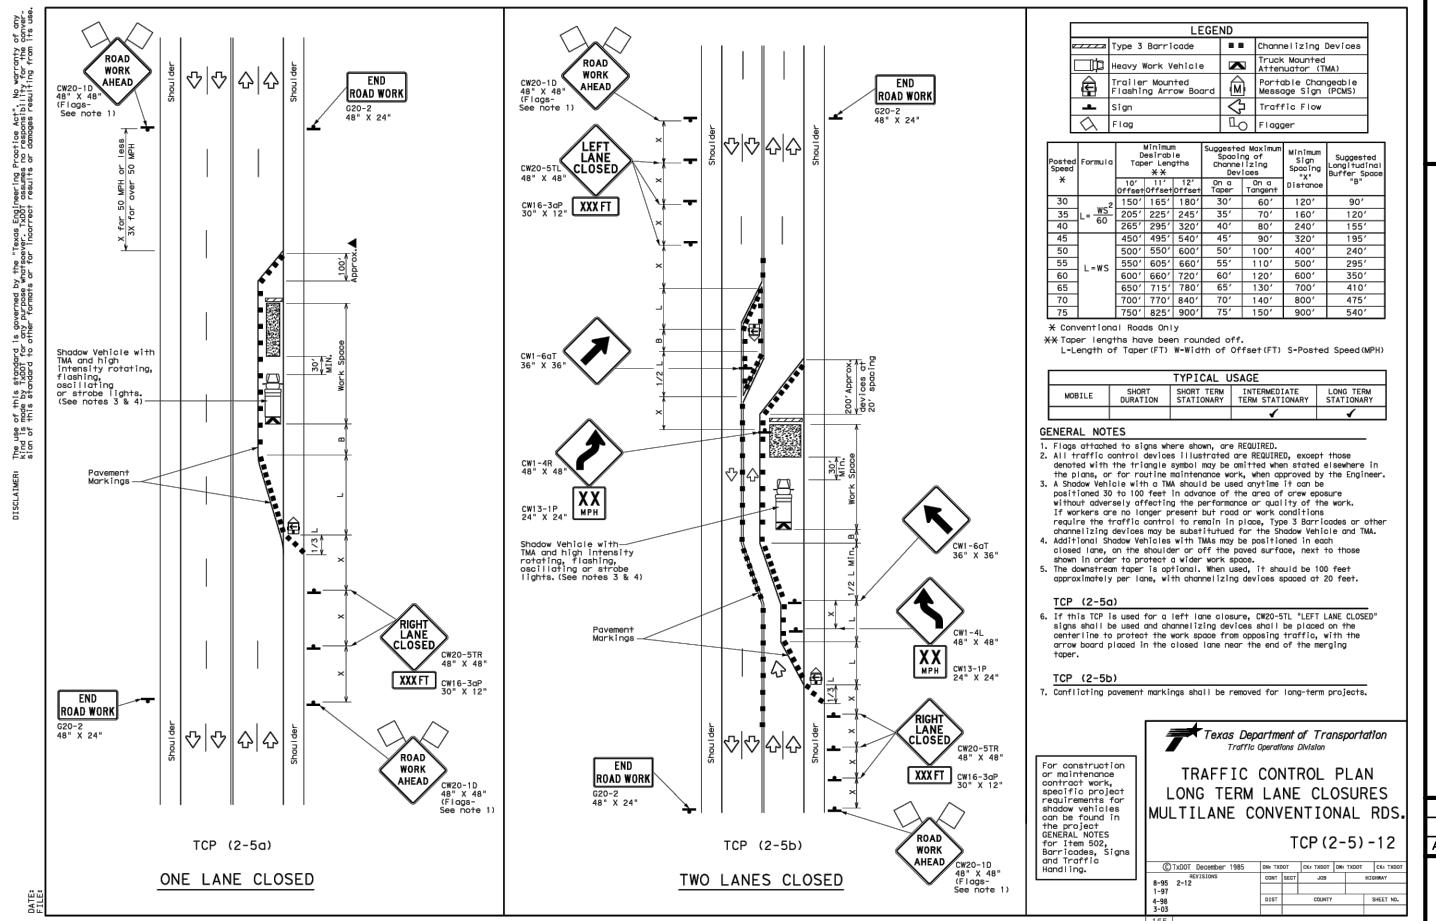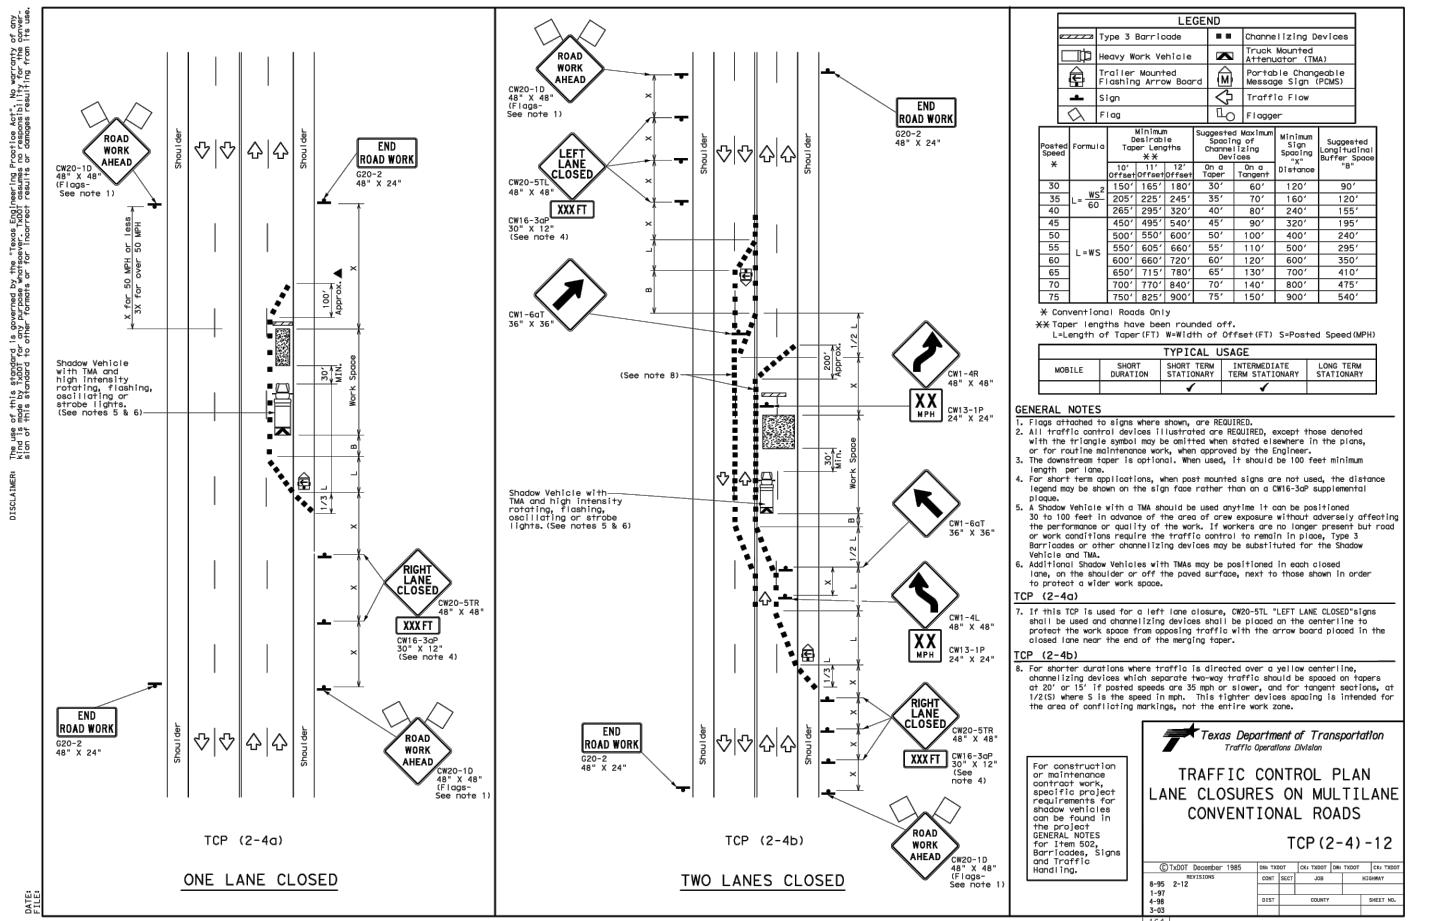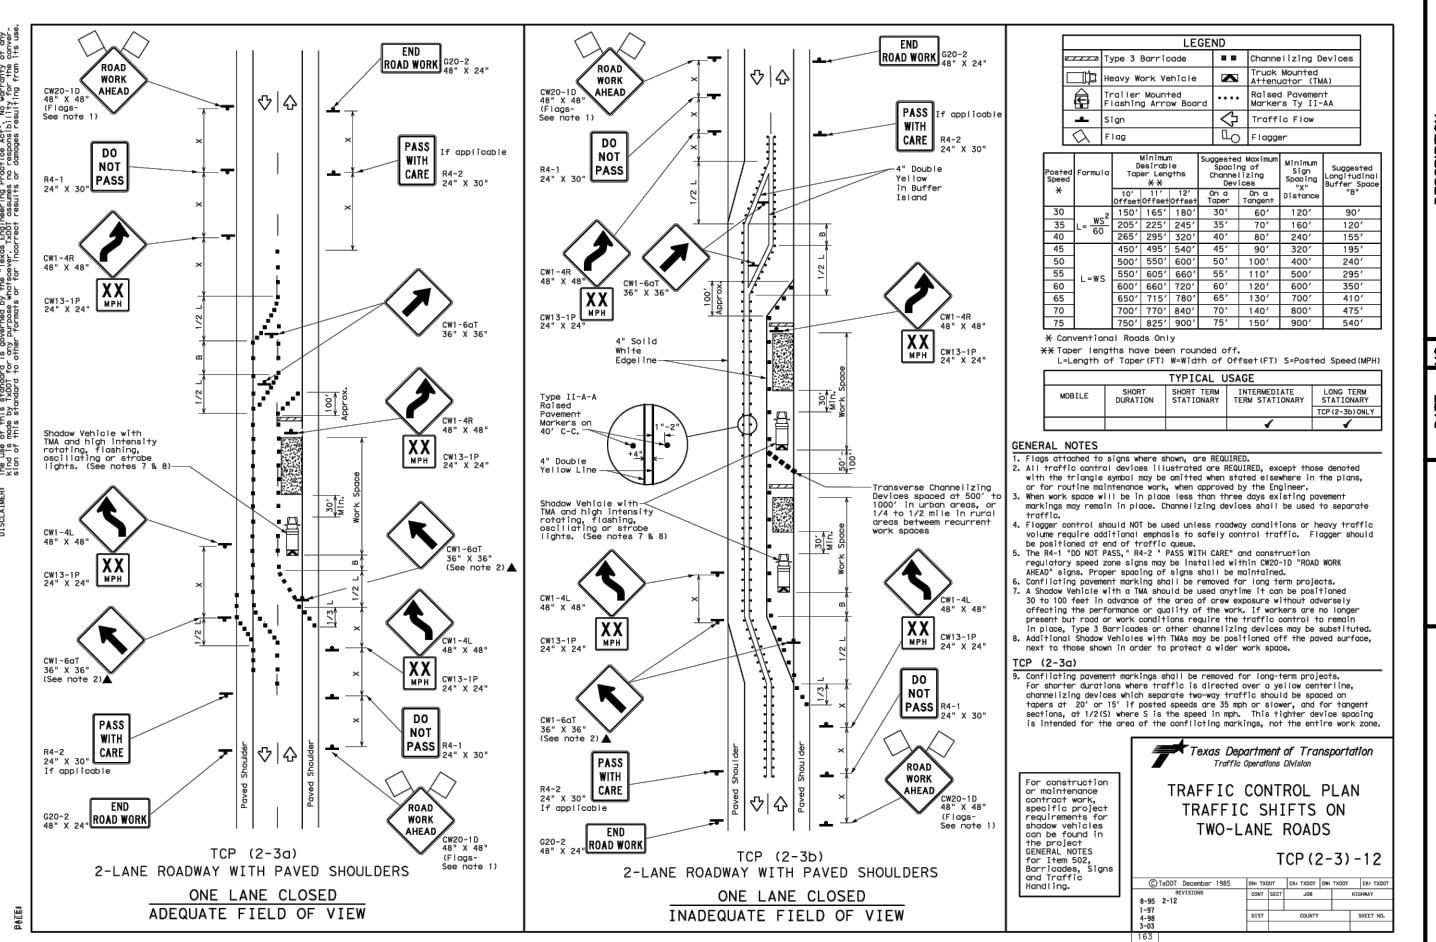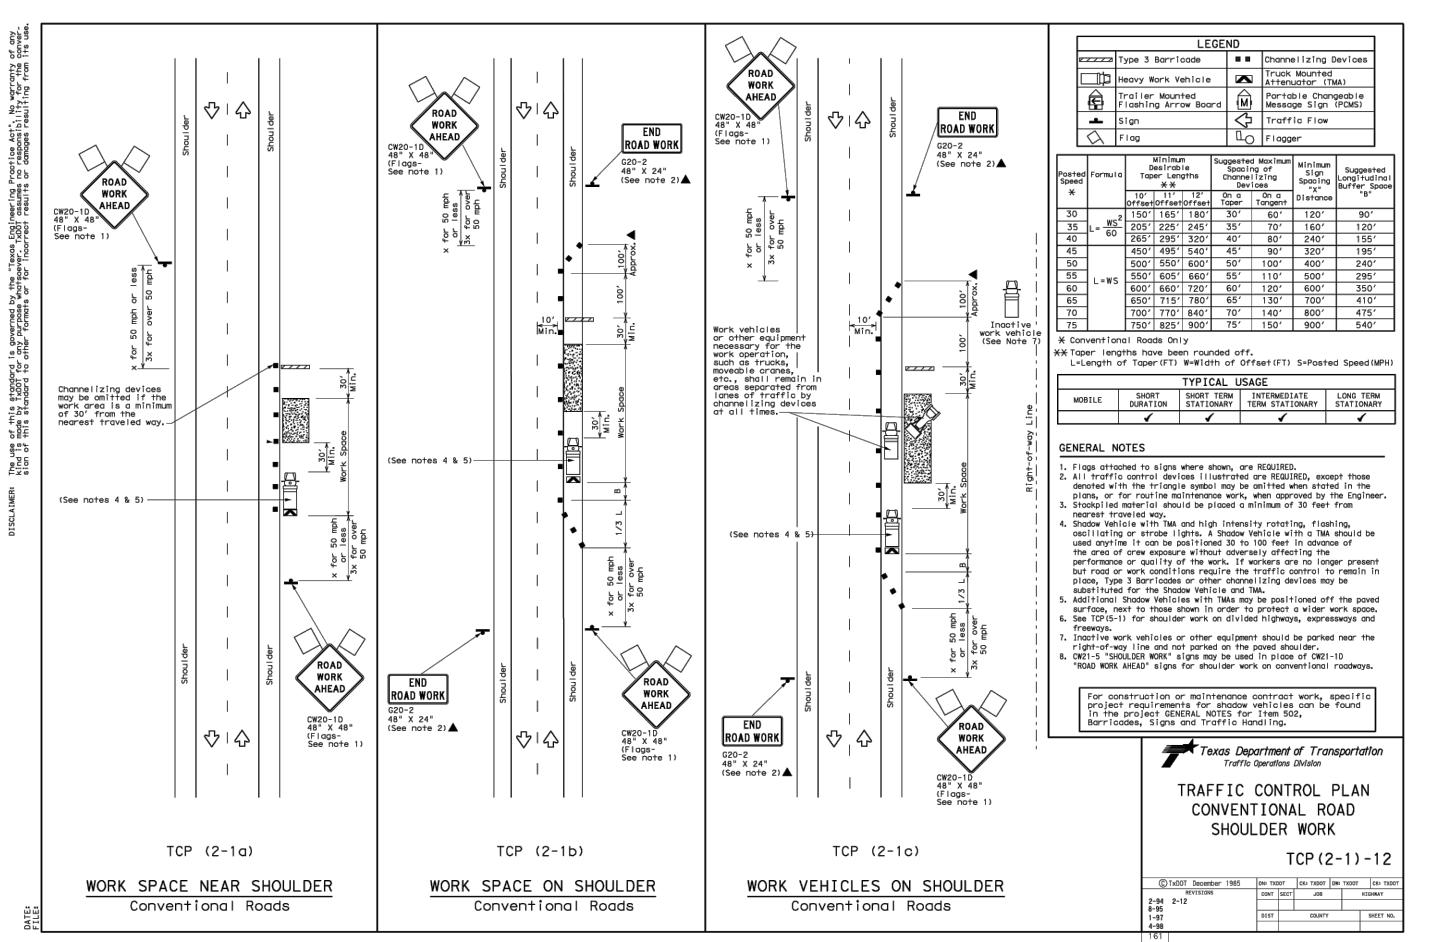

**VICKERY & ASSOCIATES, LLC.**  
**CONSULTING ENGINEERS**

TRAFFIC CONTROL STANDARDS (1 OF 2)

McQUEENEY ROAD REHABILITATION PROJ  
IH 35 N TO W COUNTY LINE RD

NEW BRAUNFELS, TEXAS 78130

12940 COUNTRY PARKWAY  
SAN ANTONIO, TX 78216  
TELEPHONE: (210) 349-2271

TELEPHONE: (210) 343-3271  
FIRM REGISTRATION NO: F-159

REHABILITATION COUNTY LINE

NEW BRAUNFELS, TEXAS

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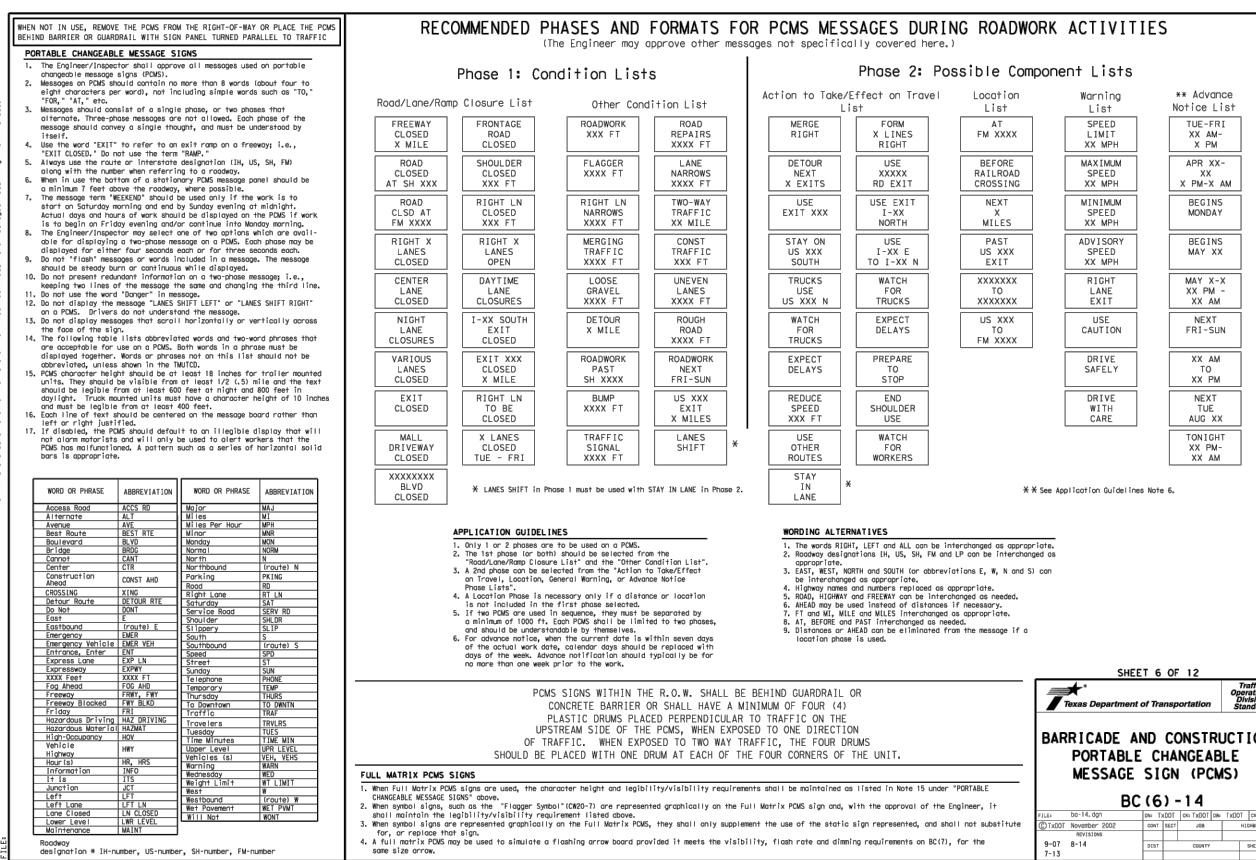
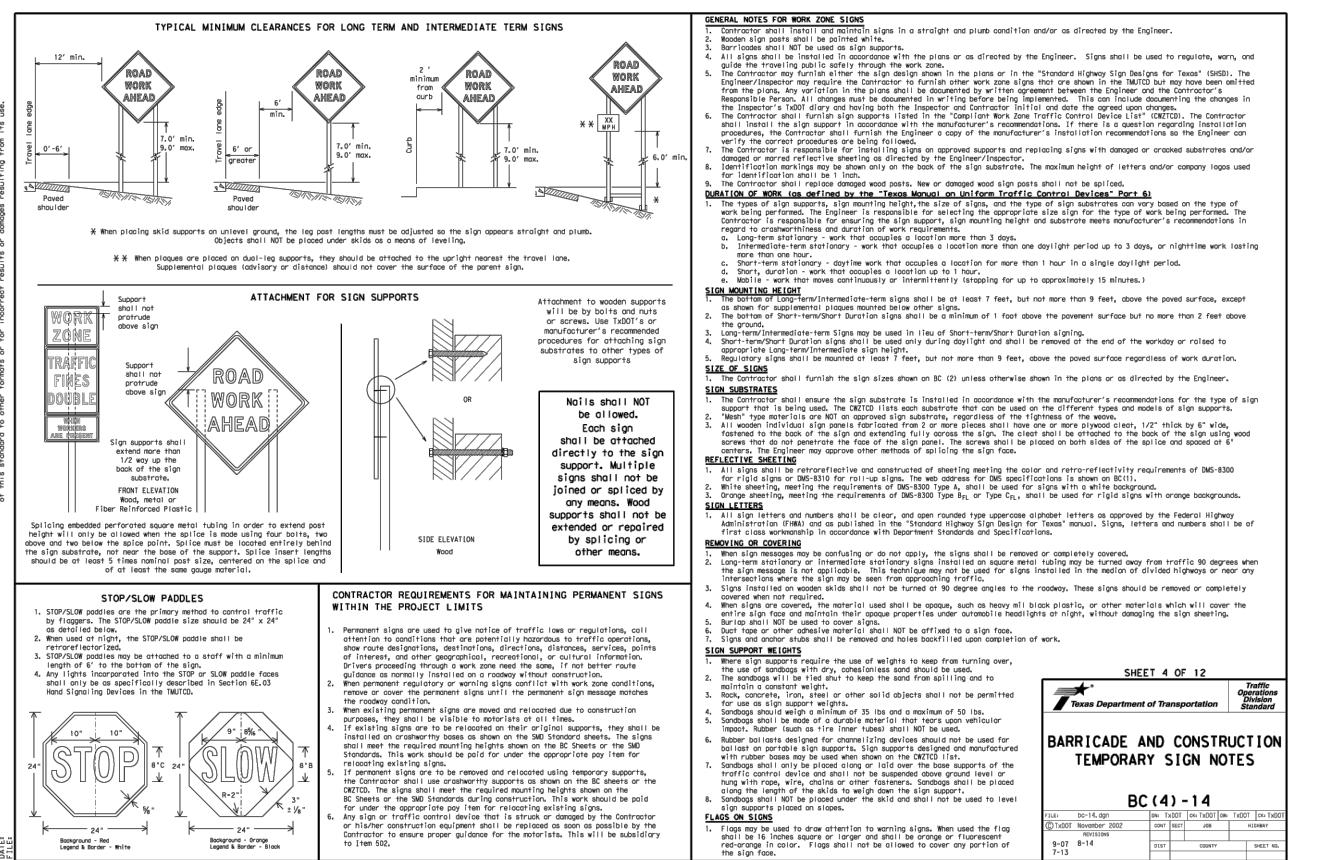
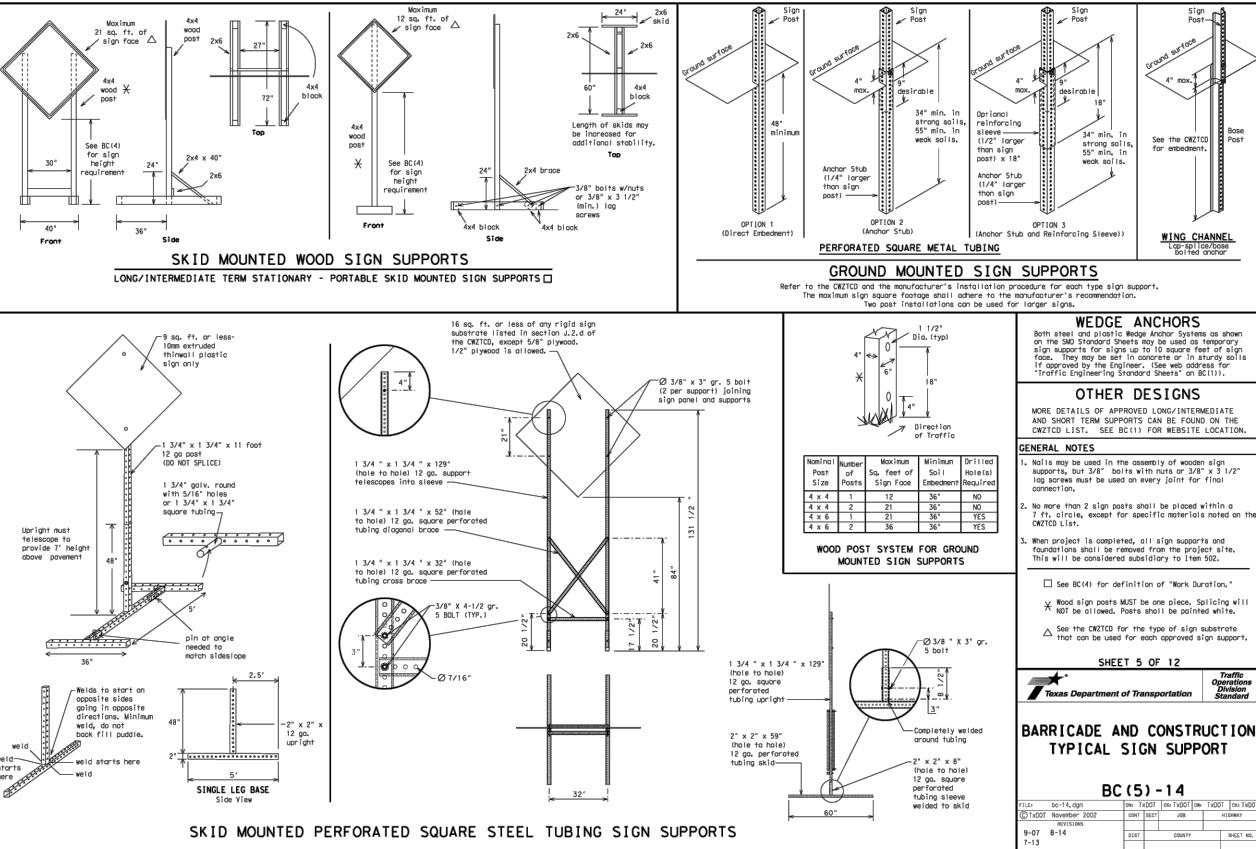
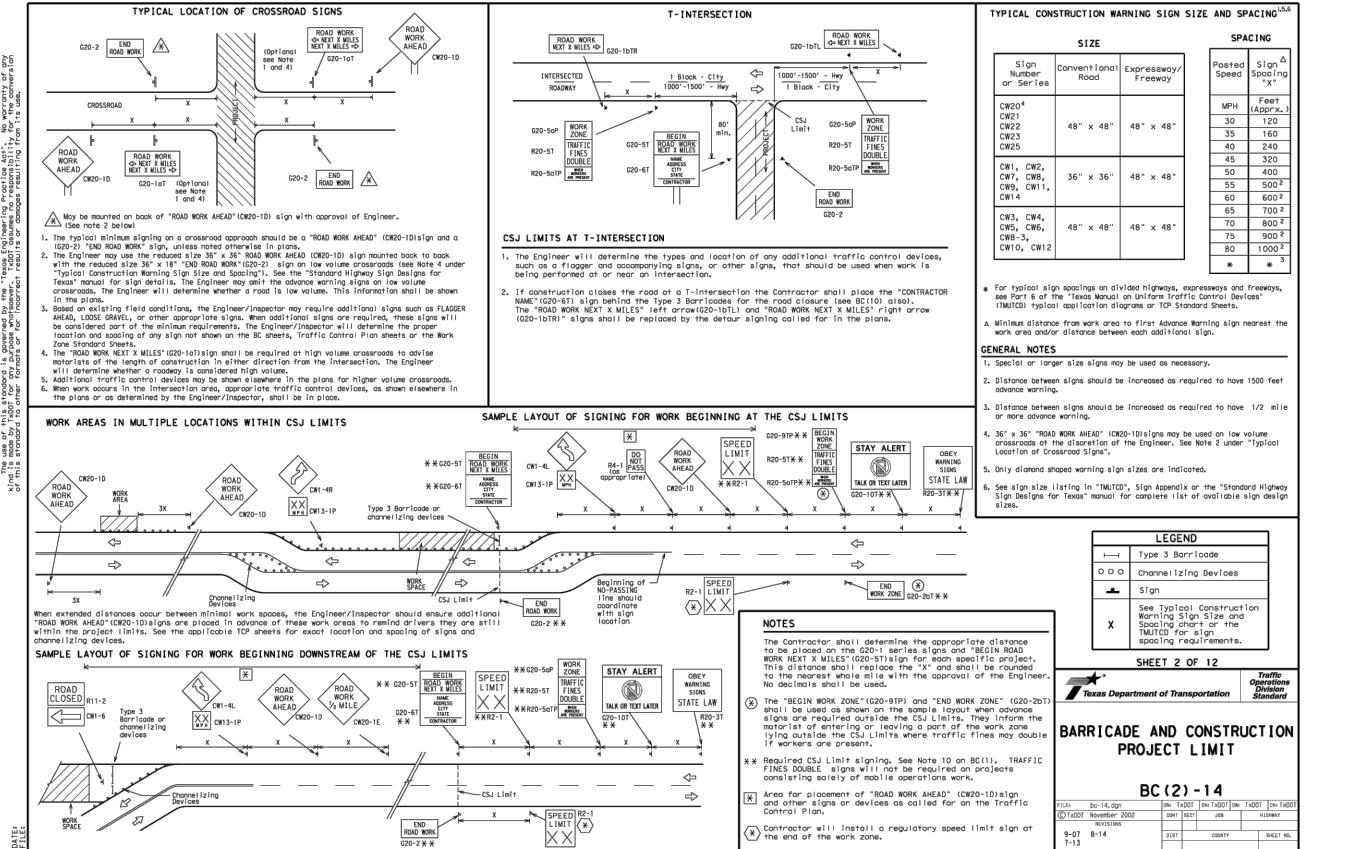
# VICKREY & ASSOCIATES, LLC.



BARRICADE STANDARDS  
(1 OF 3)

McQUEENY ROAD REHABILITATION PROJECT  
IH 35 NORTH COUNTY LINE RD  
NEW BRAUNFELS, TEXAS 78130

12940 COUNTRY PARKWAY  
SAN ANTONIO, TX 78216  
TELEPHONE: (210) 349-3271  
FIRM REGISTRATION NO: F-159



BARRICADE STANDARDS  
(1 OF 3)

McQUEENY ROAD REHABILITATION PROJECT  
IH 35 NORTH COUNTY LINE RD  
NEW BRAUNFELS, TEXAS 78130

DRAWN BY: MPC/SMH  
CHECKED BY: PAS  
APPROVED BY: ---  
SHEET 10 OF 29  
PROJ. NO. 23-00251

# VICKREY & ASSOCIATES, LLC.

CONSULTING ENGINEERS

12940 COUNTRY PARKWAY

SAN ANTONIO, TX 78216

TELEPHONE: (210) 349-3271

FIRM REGISTRATION NO: F-159

## BARRICADE STANDARDS

(2 OF 3)

MCQUEENY ROAD REHABILITATION PROJECT

IH 35 N/W COUNTY LINE RD  
NEW BRAUNFELS, TEXAS 78130

### DESCRIPTION

DATE

NO.



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**NOTES:**

1. Short term pavement markings may be prefabricated markings (stick down tape) or temporary flexible reflective roadway marker tabs unless otherwise specified elsewhere in plans.
2. Short term pavement markings shall NOT be used to simulate edge lines.
3. Dimensions indicated on this sheet are typical and approximate. Variations in size and height may occur between markers or devices made by manufacturers, by as much as 1/4 inch, unless otherwise noted.
4. Temporary flexible reflective roadway marker tabs shall require normal maintenance replacement when used on roads with speeds greater than 75 mph. If used on roads with speeds less than 75 mph, then truck mix. When roadways exceed these values, additional maintenance replacement of devices should be planned.
5. No segment of roadway open to traffic shall remain without permanent pavement markings for a period greater than 14 calendar days. The Contractor shall be responsible for installing short term pavement markings until permanent pavement markings are placed. If permanent markings are not placed within the limits of short term pavement markings, no segment of roadway shall remain without permanent pavement markings for a period greater than 14 calendar days unless weather conditions prohibit placement. Permanent pavement markings shall be placed as soon as weather permits.
6. For two lane, two-way roads DO NOT PASS signs shall be erected to mark the beginning of sections where passing is prohibited and PASS WITH CARE signs shall be erected to mark the beginning of sections where passing is permitted. Signs shall be in accordance with the "Texas Manual on Uniform Traffic Control Devices" (TUD) and shall be placed in the limits of no passing zones for up to 14 calendar days. Permanent pavement markings shall then be placed.
7. For low volume two lane, two-way roads of 4000 ADT or less, no-passing lines may be omitted when approved by the Engineer. PASS WITH CARE signs shall be used in place of no-passing lines.
8. For exits where a two-lane roadway has a single wide gore marking, reflective retroreflective channelizing devices to guide motorists through the exit, 1 channelizing device is to be used. It should be noted elsewhere in the plans. One piece cones are not allowed for this purpose.

**TEMPORARY FLEXIBLE, REFLECTIVE ROADWAY MARKER TABS (TABS)**

1. Temporary flexible reflective roadway marker tabs detailed on this sheet will be designated Type Y-2 (two outer reflective surfaces with yellow body; Type Y one outer reflective surface with yellow body); and Type W (one white or silver reflective surface with white body). Additional details may be found on BC(11).

2. Tabs shall meet requirements of Departmental Material Specification DMS-8242.

3. These tabs shall be visible for a minimum distance of 200 feet during normal daylight hours and when illuminated by automobile low-beam head light right or left, unless sight distance is restricted by roadway geometrics.

4. Two consecutive tabs nor four tabs per 1000 feet of line shall be missing or fail to meet the visual performance requirements of Note 3.

**WORK ZONE SHORT TERM PAVEMENT MARKINGS DETAILS**

**SOLID LINES**

**BROKEN LINES**

**WIDE DOTTED LINES**

**WIDE GORE MARKINGS**

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**WORK ZONE SHORT TERM PAVEMENT MARKINGS PATTERNS**

**CENTER LINE & NO-PASSING ZONE BARRIER LINES FOR TWO LANE TWO-WAY HIGHWAYS**

**LANE LINES FOR DIVIDED HIGHWAY**

**LANE & CENTER LINES FOR MULTILANE UNDIVIDED HIGHWAYS**

**TWO-WAY LEFT TURN LANE**

**PREFABRICATED PAVEMENT MARKINGS**

1. Temporary Removable Prefabricated Pavement Markings shall meet the requirements of DMS-8241.

2. Non-removable Prefabricated Pavement Markings shall meet the requirements of either DMS-8240 "Permanent Prefabricated Pavement Markings" or DMS-8243 "Temporary Construction-Grade Prefabricated Pavement Markings".

**RAISED PAVEMENT MARKERS**

1. All raised pavement markers used for work zone markings shall meet the requirements of Item 6720, "RAISED PAVEMENT MARKERS" and DMS-4200.



**DEPARTMENTAL MATERIAL SPECIFICATIONS (DMS) & MATERIAL PRODUCER LISTS (MPL)**

1. DMS referenced above can be found along with embedded links to their respective MPLs at the following website: [http://www.txdot.gov/business/contractors\\_consultants/material\\_specifications/default.htm](http://www.txdot.gov/business/contractors_consultants/material_specifications/default.htm)

**Texas Department of Transportation**

**WORK ZONE SHORT TERM PAVEMENT MARKINGS**

**WZ (STPM) - 13**

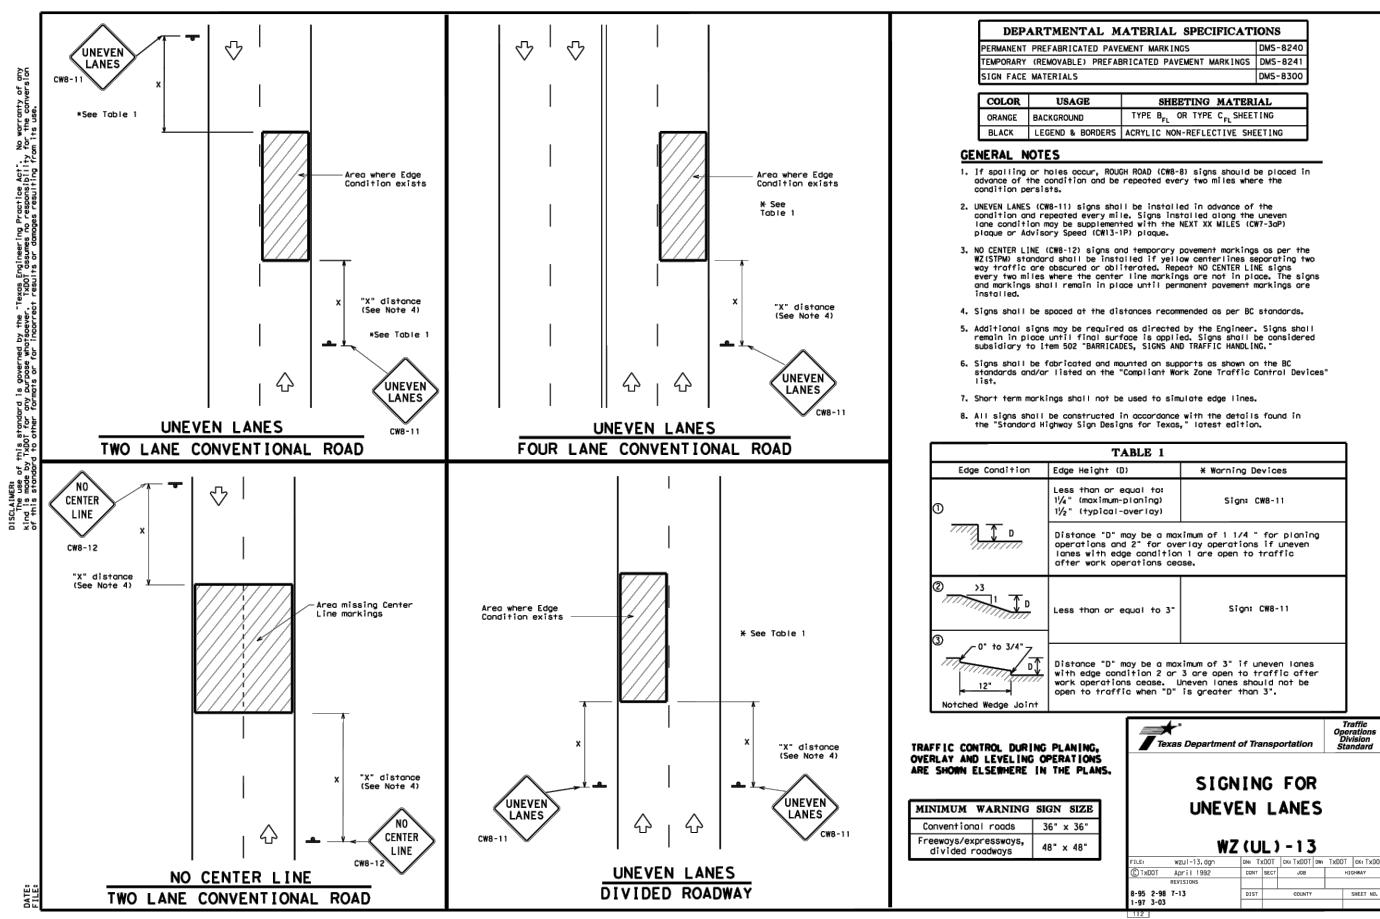
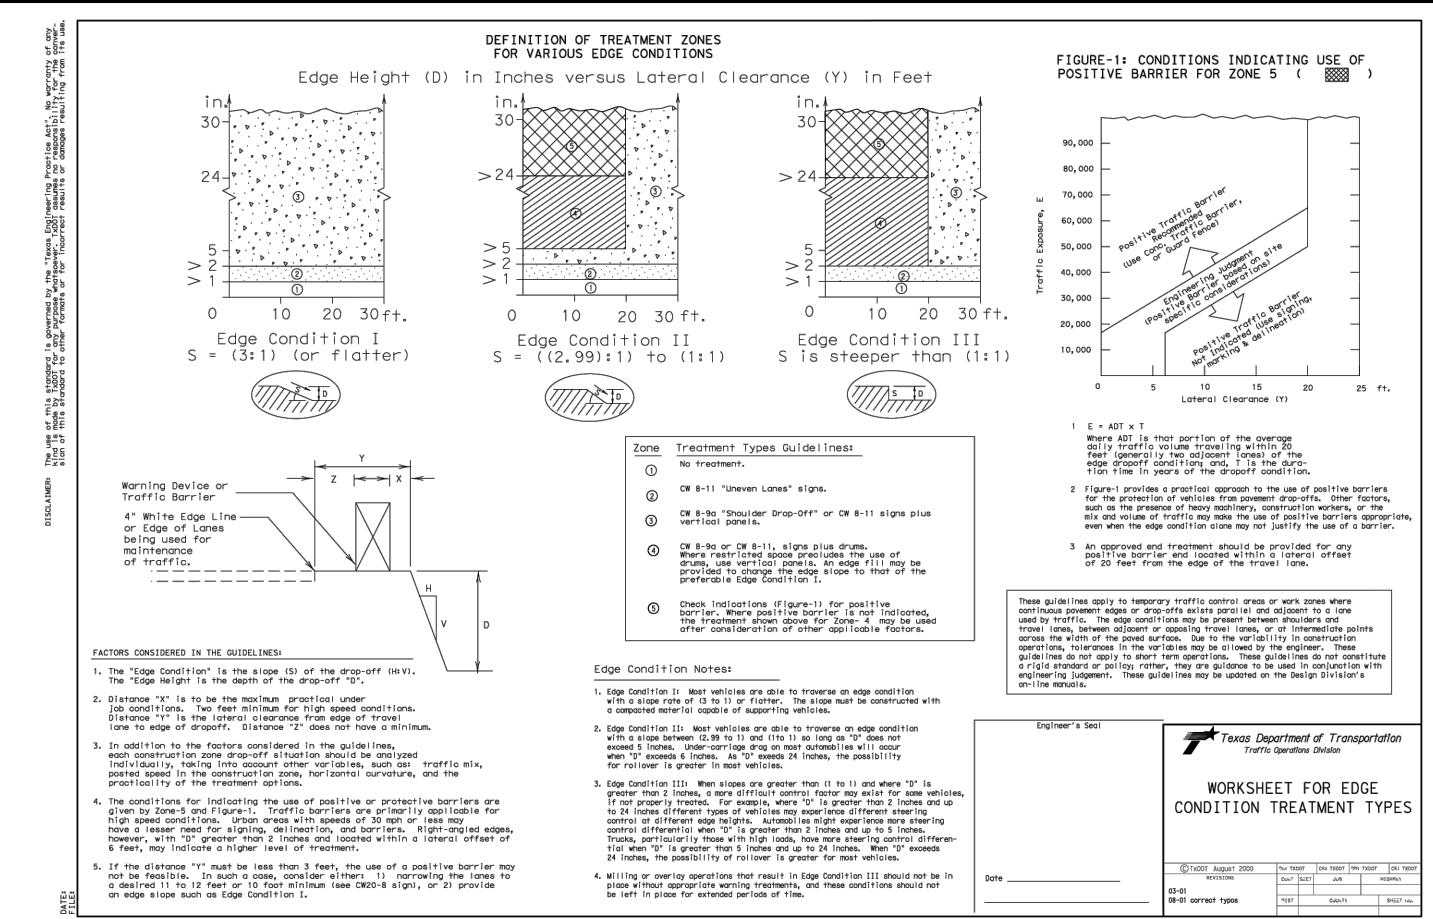


## WORK ZONE STANDARDS

QUEENY ROAD REHABILITATION PROJECT  
IH 35 N TO W COUNTY LINE RD  
NEW BRAUNFELS, TEXAS 78130

REY & ASSOCIATES, LLC.  
INSTITUTE FOR ENTERPRISE

**CONSULTING ENGINEERS**  
12940 COUNTRY PARKWAY  
SAN ANTONIO, TX 78216  
TELEPHONE: (210) 349-3271

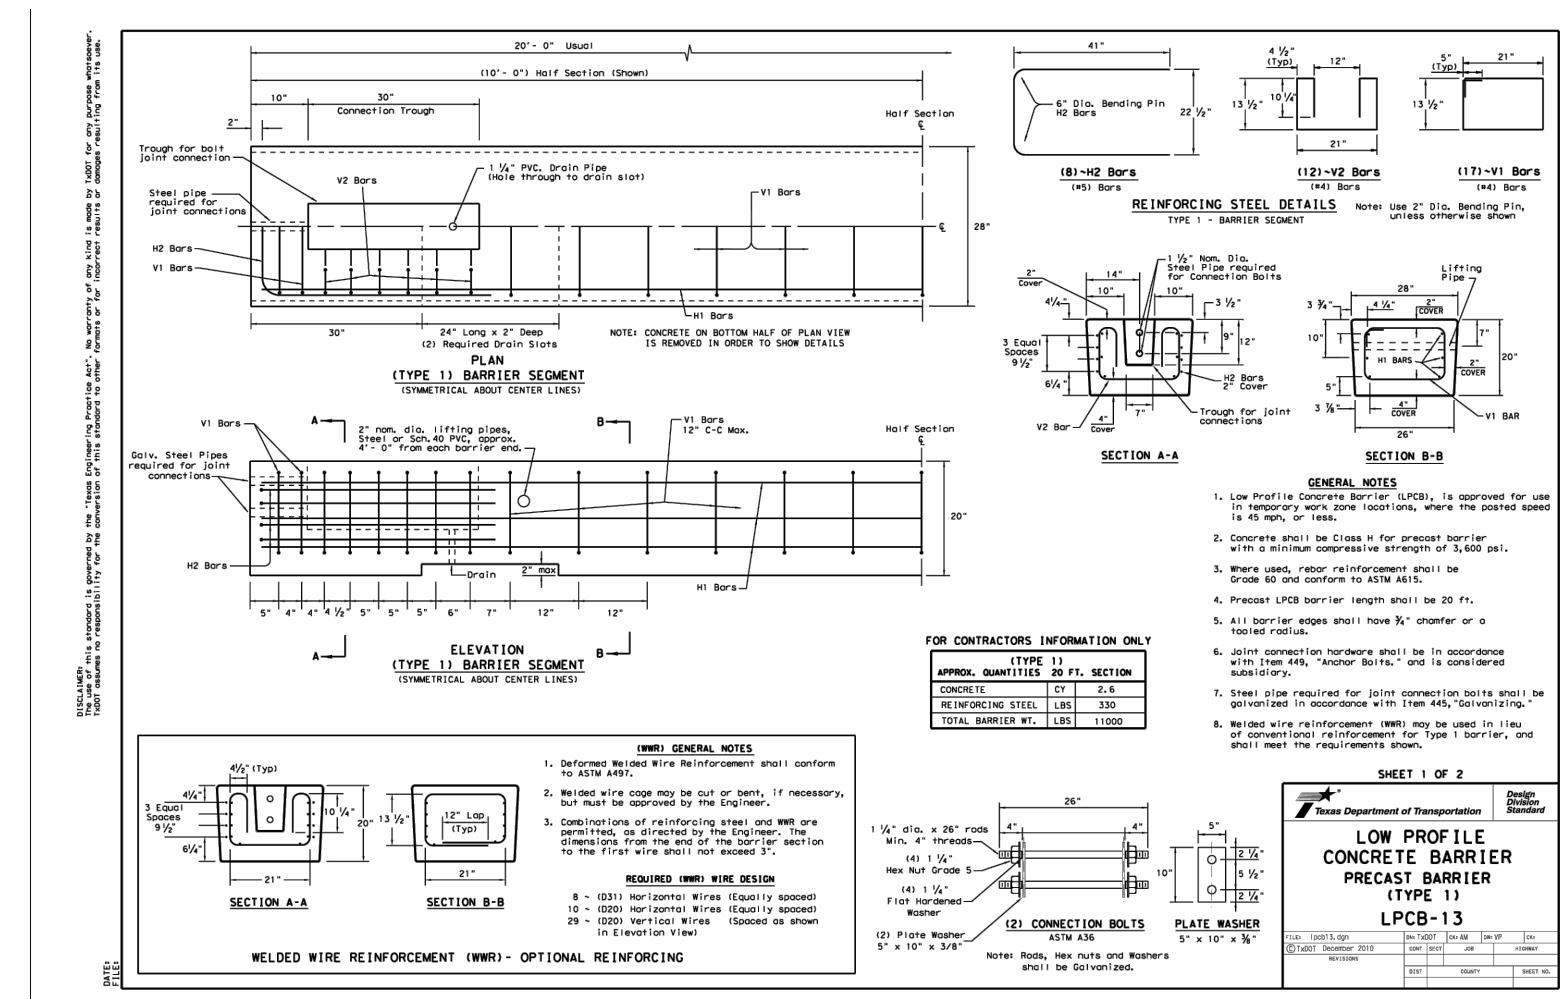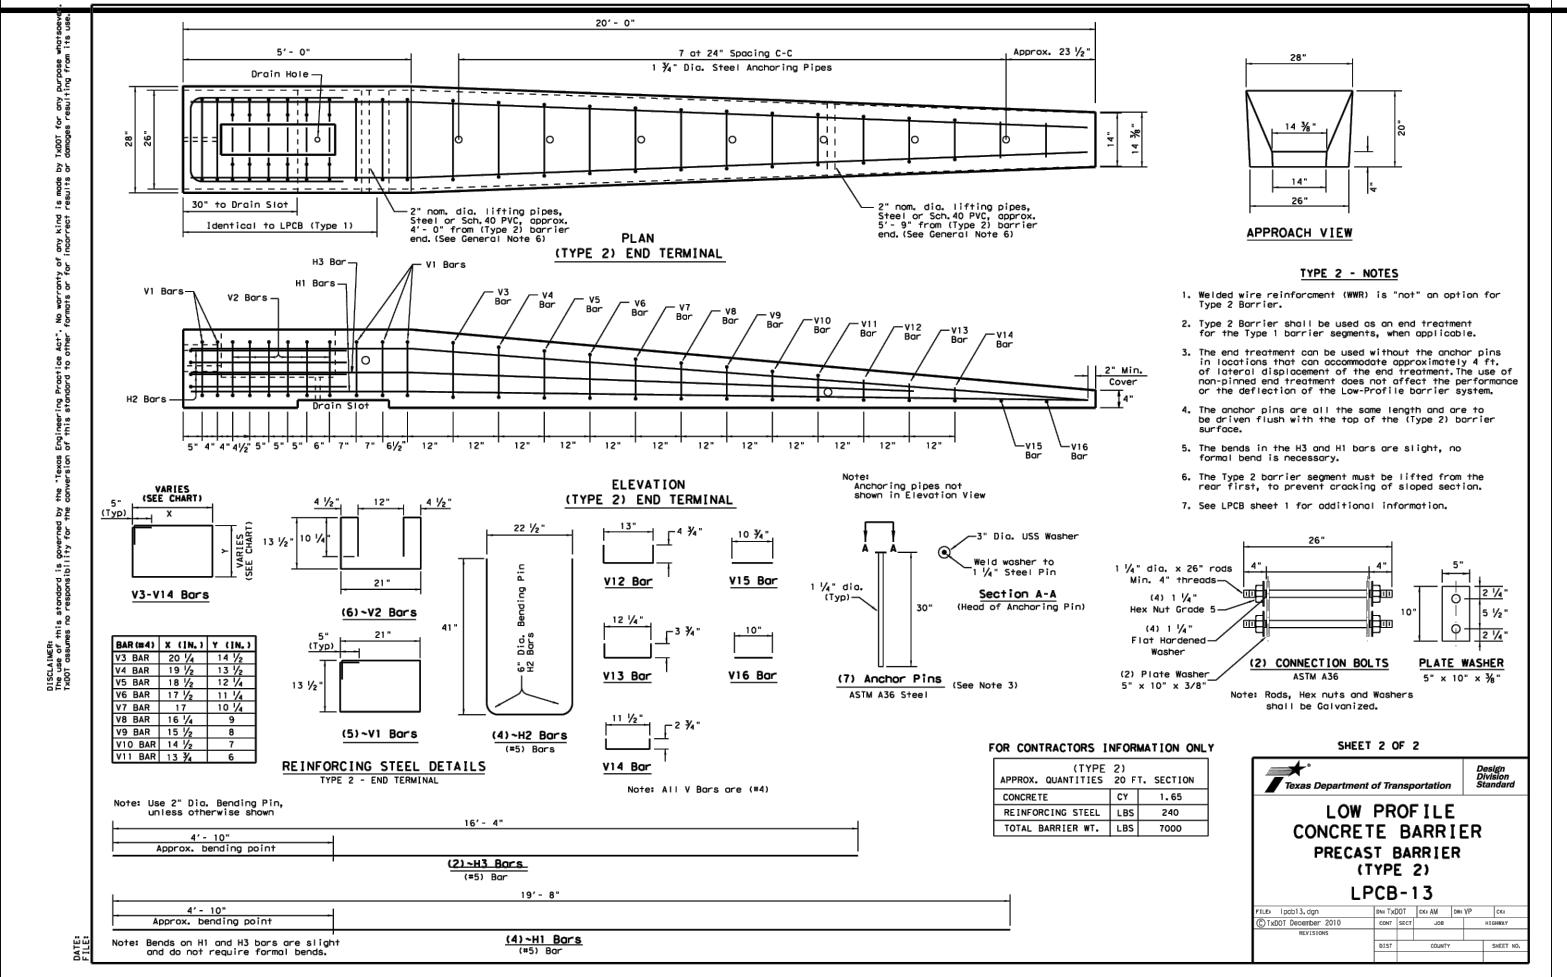

**TCEQ**  
**WATER POLLUTION ABATEMENT PLAN**  
**GENERAL CONSTRUCTION NOTES**

THERE ARE NO SWPPP REQUIREMENTS FOR THE PAVING REPAIR AND OVERLAY PORTIONS OF THE PROJECT.

PRIOR TO BEGINNING SIDEWALK AND DRIVEWAY CONSTRUCTION, INLET PROTECTION SHALL BE PLACED AROUND THE INLET AT THE SOUTHEAST CORNER OF IH35 AND MCQUEENEY ROAD.

SILT FENCE SHALL BE PLACED ALONG THE ROW FROM:

- ALONG THE RIGHT SIDE OF THE CONCRETE CHANNEL FROM STATION 2+25 TO 3+00 (RIGHT) AND 3+90 TO 4+75 (RIGHT)
- AT STATION 11+00 (LEFT) TO STATION 11+80 AND PERPENDICULAR TO THE ROW
- ALONG THE LEFT ROW FROM STATION 11+00 TO 14+25
- ALONG THE RIGHT ROW FROM STATION 13+45 TO 17+00
- ALONG THE LEFT ROW FROM STATION 19+50 TO 20+35
- ALONG THE LEFT ROW FROM STATION 20+75 TO 22+90
- ALONG THE LEFT ROW FROM STATION 23+50 TO 25+00
- ALONG THE LEFT ROW FROM STATION 26+1- TO 29+25
- ALONG THE LEFT ROW FROM STATION 41+40 TO 53+35

A ROCK FILTER DAM WILL NEED TO BE PLACED AT:


- AT THE NORTHEAST CORNER OF MCQUEENEY RD AND TRADE CENTER DR.
- AT THE NORTHWEST CORNER OF MCQUEENEY RD AND EXECUTIVE DR.
- AT STATION 12+50 RIGHT AND LEFT
- AT STATION 29+25 LEFT
- AT STATION 55+00 LEFT

**TEMPORARY POLLUTION ABATEMENT NOTES**


1. THE CONTRACTOR IS RESPONSIBLE FOR PLACING SILT FENCE ALONG THE DOWN GRADIENT SIDE OF THE DISTURBED AREA PERPENDICULAR TO THE DRAINAGE FLOW.
2. GRAVEL FILTER BAGS SHALL BE PLACED IN AREAS WHERE DRAINAGE FLOW IS CONCENTRATED DUE TO NATURAL CONDITIONS OR CONSTRUCTION ACTIVITIES SUCH AS AT DRAINAGE STRUCTURES. THESE BAGS WILL BE MAINTAINED UNTIL THEY ARE NO LONGER NEEDED OR UNTIL THEY ARE REPLACED WITH PERMANENT POLLUTION ABATEMENT MEASURES.

**GENERAL NOTES**

1. DO NOT DISTURB VEGETATED AREAS (TREES, GRASS, WEEDS, BRUSH, ETC.) ANY MORE THAN NECESSARY FOR CONSTRUCTION.
2. LOCATIONS OF CONCRETE WASHOUT PITS, AND CONSTRUCTION EQUIPMENT AND MATERIAL STORAGE YARDS TO BE DETERMINED IN THE FIELD.
3. STORMWATER POLLUTION PREVENTION CONTROLS MAY NEED TO BE MODIFIED IN THE FIELD TO ACCOMPLISH THE DESIRED EFFECT. ALL MODIFICATIONS ARE TO BE NOTED ON THIS EXHIBIT AND SIGNED AND DATED BY THE RESPONSIBLE PARTY.
4. ALL STORMWATER POLLUTION PREVENTION CONTROLS ARE TO BE MAINTAINED AND IN WORKING CONDITIONS AT ALL TIMES.
5. CONTRACTOR, TO THE EXTENT PRACTICAL, SHALL MINIMIZE THE AMOUNT OF AREA DISTURBED. AS SOON AS PRACTICAL, ALL DISTURBED SOIL THAT WILL NOT BE COVERED BY IMPERVIOUS COVER SUCH AS PARKWAY AREAS, EASEMENT AREAS, EMBANKMENT SLOPES, ETC. WILL BE STABILIZED PER APPLICABLE PROJECT SPECIFICATIONS.
6. BEST MANAGEMENT PRACTICES MAY BE INSTALLED IN STAGES TO COINCIDE WITH THE DISTURBANCE OF UPGRADENT AREAS.
7. BEST MANAGEMENT PRACTICES MAY BE REMOVED IN STAGES ONCE THE WATERSHED FOR THAT PORTION CONTROLLED BY THE BEST MANAGEMENT PRACTICES HAS BEEN STABILIZED.
8. ALL TEMPORARY BMPs WILL BE REMOVED ONCE WATERSHED IS STABILIZED.
9. MUD OR DIRT INADVERTENTLY TRACKED OFF-SITE AND ONTO EXISTING STREETS SHALL BE REMOVED IMMEDIATELY BY HAND OR MECHANICAL BROOM SWEEPING.
10. PRIOR TO INITIATION OF SUBSEQUENT PHASES OF CONSTRUCTION, TEMPORARY BMPs INCLUDING SILT FENCING, CONSTRUCTION ENTRANCE/EXIT, CONCRETE WASHOUT PIT, AND CONSTRUCTION STAGING AREA SHALL BE FIELD LOCATED AS APPROPRIATE FOR THE AREA OF CONSTRUCTION.
11. TEMPORARY POLLUTION ABATEMENT MEASURES ARE FOR THE OVERALL DEVELOPMENT. TEMPORARY BMPs MAY REQUIRE ADJUSTMENT BASED ON PHASING OF CONSTRUCTION OF THE DEVELOPMENT. RECORDS OF ADJUSTMENTS AND REVISIONS SHALL BE MAINTAINED AS APPROPRIATE.
12. UPON COMPLETION OF THE PROJECT AND BEFORE FINAL PAYMENT IS ISSUED, CONTRACTOR SHALL REMOVE ALL SEDIMENT AND EROSION CONTROL MEASURES.
13. CONTRACTOR SHALL BE RESPONSIBLE FOR CONSTRUCTION SEQUENCING AND REMOVAL OF TEMPORARY POLLUTION ABATEMENT MEASURES THAT CONFLICT WITH SITE IMPROVEMENTS SUCH AS LANDSCAPING AND FENCES SO AS TO PREVENT SEDIMENT FROM ESCAPING THE PROJECT SITE.

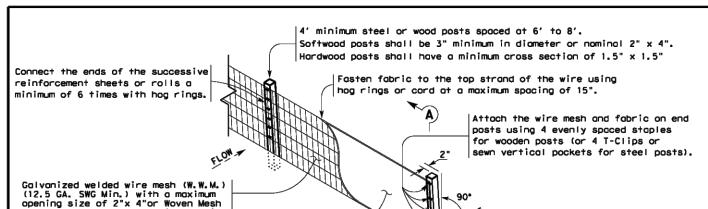


TEMPORARY SEDIMENT CONTROL FENCE

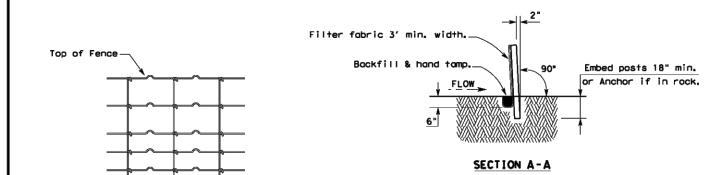


HINGE JOINT KNOT WOVEN MESH (OPTION) DETAIL



Galvanized hinge joint knot woven mesh (12.5 GA SWG Min.) requires a minimum of five horizontal wires spaced at a maximum of 12 inches apart and all vertical wires spaced at a maximum of 12 inches apart.

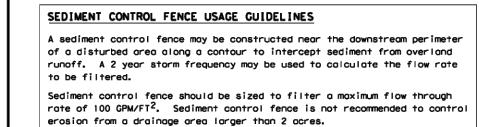


LEGEND  
Sediment Control Fence

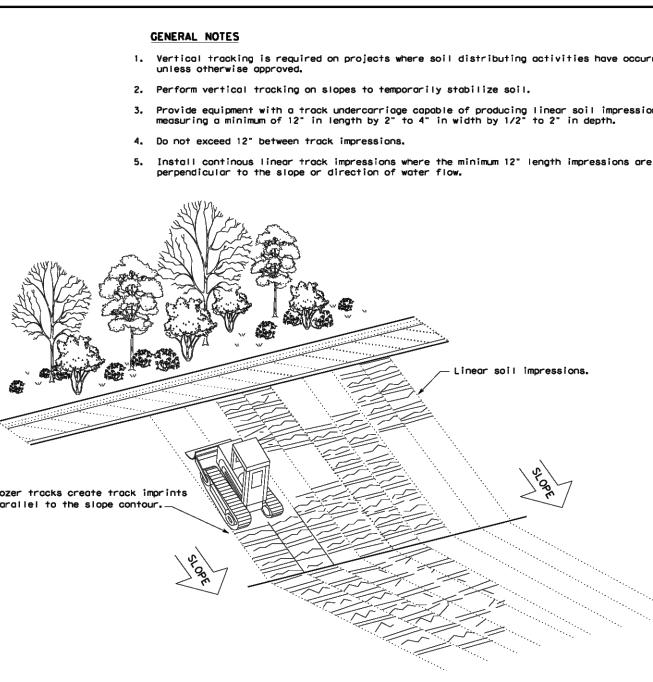

VERTICAL TRACKING

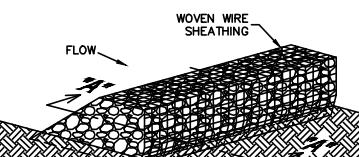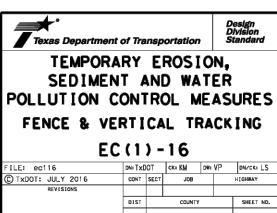

ISOMETRIC PLAN VIEW

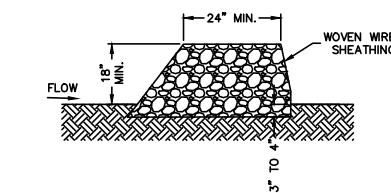

SECTION "A-A"

**ROCK BERMS**

THE PURPOSE OF A ROCK BERM IS TO SERVE AS A CHECK DAM IN AREAS OF CONCENTRATED FLOW, TO INTERCEPT SEDIMENT-LADEN RUNOFF, DETAIN THE SEDIMENT AND RELEASE THE WATER IN SHEET FLOW. THE ROCK BERM SHOULD BE USED WHEN THE CONTRIBUTING DRAINAGE AREA IS LESS THAN 5 ACRES. ROCK BERMS ARE USED IN AREAS WHERE THE VOLUME OF RUNOFF IS TOO GREAT FOR A SILT FENCE TO CONTAIN THEM. THEY ARE USEFUL FOR SEDIMENT REMOVAL THAN SILT FENCES, PARTICULARLY FOR FINE PARTICLES, BUT ARE ABLE TO WITHSTAND HIGHER FLOWS THAN A SILT FENCE. AS SUCH, ROCK BERMS ARE OFTEN USED IN AREAS OF CHANNEL FLOWS (DITCHES, GULLIES, ETC.). ROCK BERMS ARE MOST EFFECTIVE AT REDUCING BED LOAD IN CHANNELS AND SHOULD NOT BE SUBSTITUTED FOR OTHER EROSION AND SEDIMENT CONTROL MEASURES FARTHER UP THE WATERSHED.

**MATERIALS**

1. THE BERM STRUCTURE SHOULD BE SECURED WITH A WOVEN WIRE SHEATHING HAVING MAXIMUM OPENING OF 1 INCH AND A MINIMUM WIRE DIAMETER OF 20 GAUGE GALVANIZED AND SHOULD BE SECURED WITH SHOAT RINGS.
2. CLEAN, OPEN GRADED 3-INCH TO 5-INCH DIAMETER ROCK SHOULD BE USED, EXCEPT IN AREAS WHERE HIGH VELOCITIES OR LARGE VOLUMES OF FLOW ARE EXPECTED, WHERE 5-INCH TO 8-INCH DIAMETER ROCKS MAY BE USED.

**INSPECTION AND MAINTENANCE GUIDELINES**

1. INSPECTION SHOULD BE MADE WEEKLY AND AFTER EACH RAINFALL BY THE RESPONSIBLE PARTY. FOR INSTALLATIONS IN STREAMBEDS, ADDITIONAL DAILY INSPECTIONS SHOULD BE MADE.
2. REMOVE SEDIMENT AND OTHER DEBRIS WHEN BUILDUP REACHES 6 INCHES AND DISPOSE OF THE ACCUMULATED SILT IN AN APPROVED MANNER THAT WILL NOT CAUSE ANY ADDITIONAL SILTATION.
3. REPAIR ANY LOOSE WIRE SHEATHING.
4. THE BERM SHOULD BE RESHAPED AS NEEDED DURING INSPECTION.
5. THE BERM SHOULD BE REPLACED WHEN THE STRUCTURE CEASES TO FUNCTION AS INTENDED, OR SILT ACCUMULATION AMONG THE ROCKS, WASHERS, OR CONSTRUCTION TRAFFIC DAMAGE, ETC.
6. THE ROCK BERM SHOULD BE LEFT IN PLACE UNTIL ALL UPSTREAM AREAS ARE STABILIZED AND ACCUMULATED SILT REMOVED.

**ROCK BERM DETAIL**


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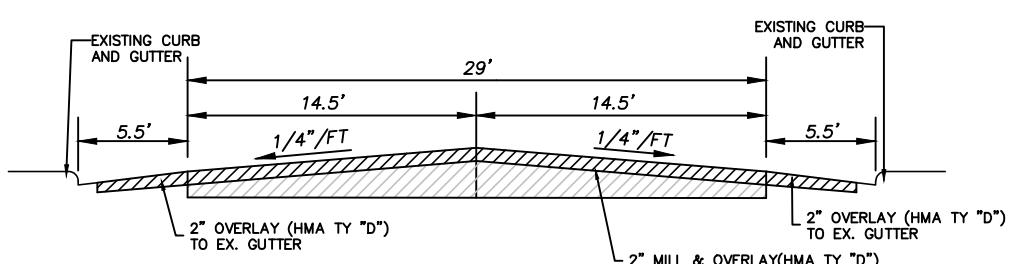
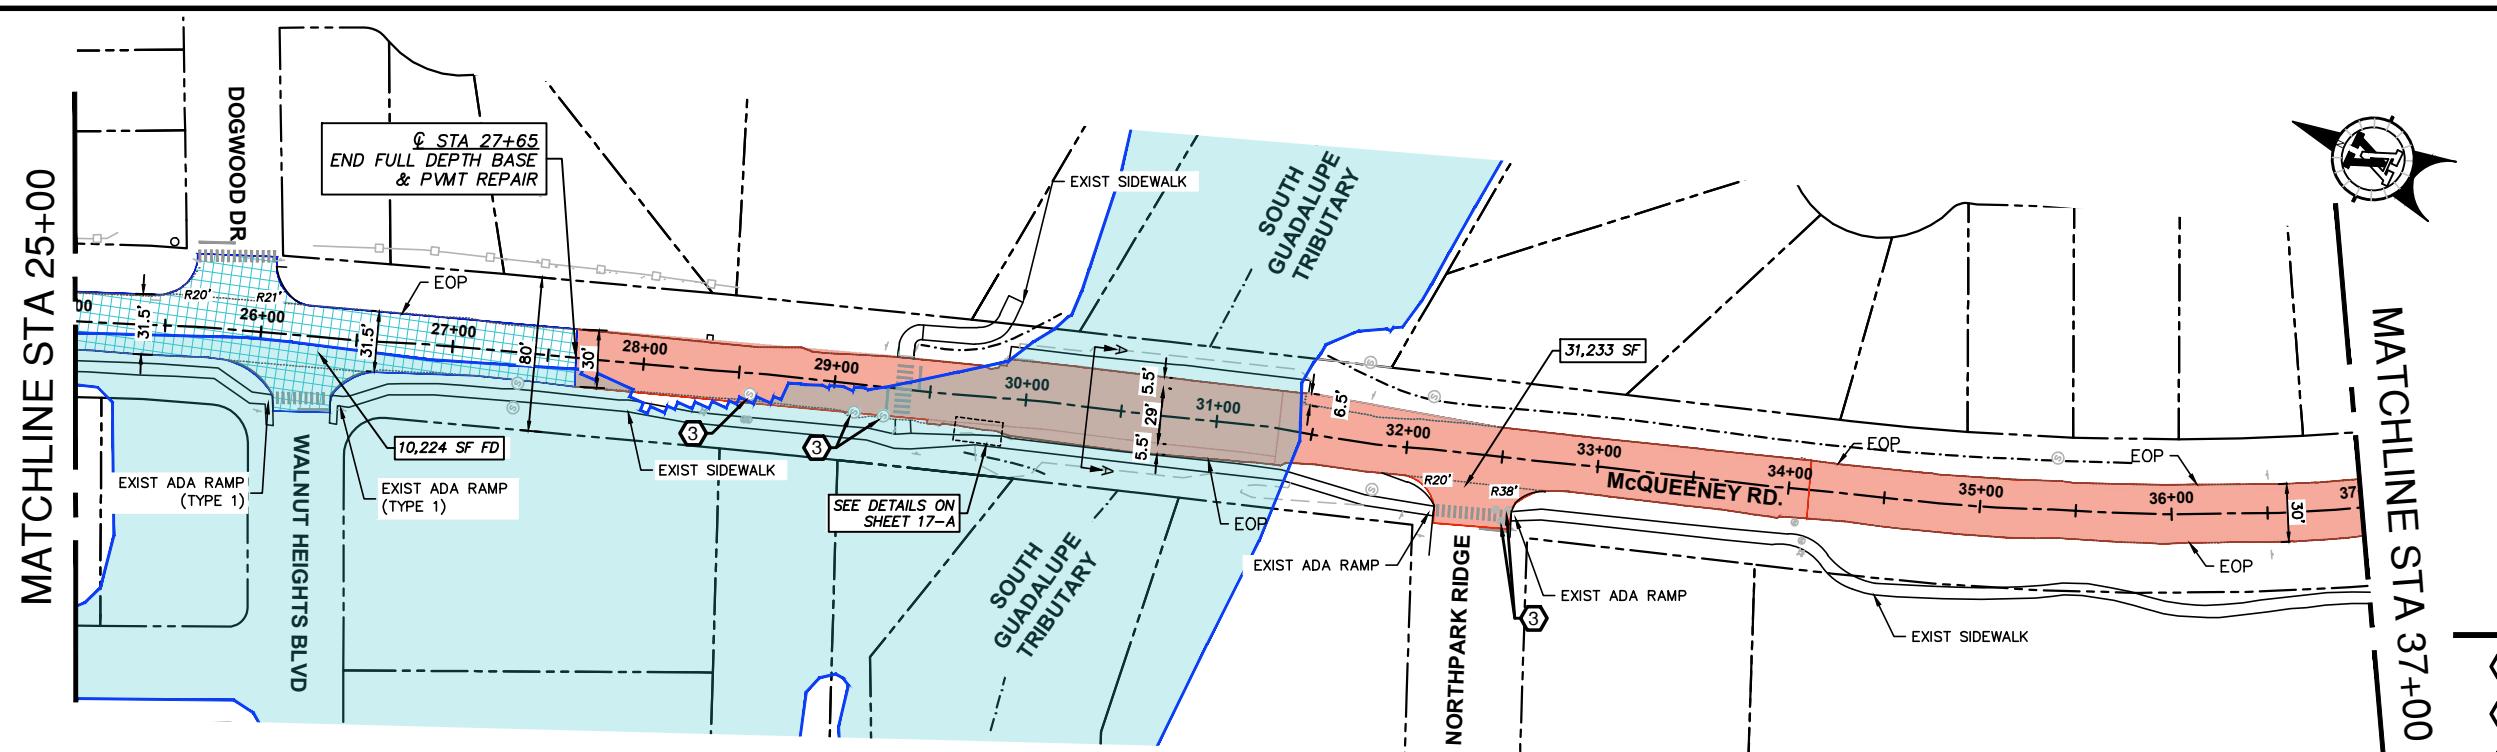
TEMP EROSION CONTROL NARRATIVE  
IH 35 N TO W COUNTY LINE RD  
NEW BRAUNFELS, TEXAS 78130  
McQUEENEY ROAD REHABILITATION PROJECT  
Drawing No. 23-00251 VICKREY & ASSOCIATES, LLC  
Date: 07/27/2016

DRAWN BY: MPC/SMH  
CHECKED BY: PAS  
APPROVED BY: ---  
SHEET 15 OF 29  
PROJ. NO. 23-00251

Texas Department of Transportation  
Design Division Standard  
TEMPORARY EROSION,  
SEDIMENT AND WATER  
POLLUTION CONTROL MEASURES  
FENCE & VERTICAL TRACKING  
EC(1)-16  
FILE# ec0116 DATE 07/2016  
C0001 SECT 000 JOB 00004 LS  
REVISIONS  
DIST. COUNTY SHEET NO.  
12940 COUNTRY PARKWAY  
SAN ANTONIO, TX 78216  
TELEPHONE: (210) 349-3271  
FIRM REGISTRATION NO: F-159


**VICKREY & ASSOCIATES, LLC.**  
CONSULTING ENGINEERS



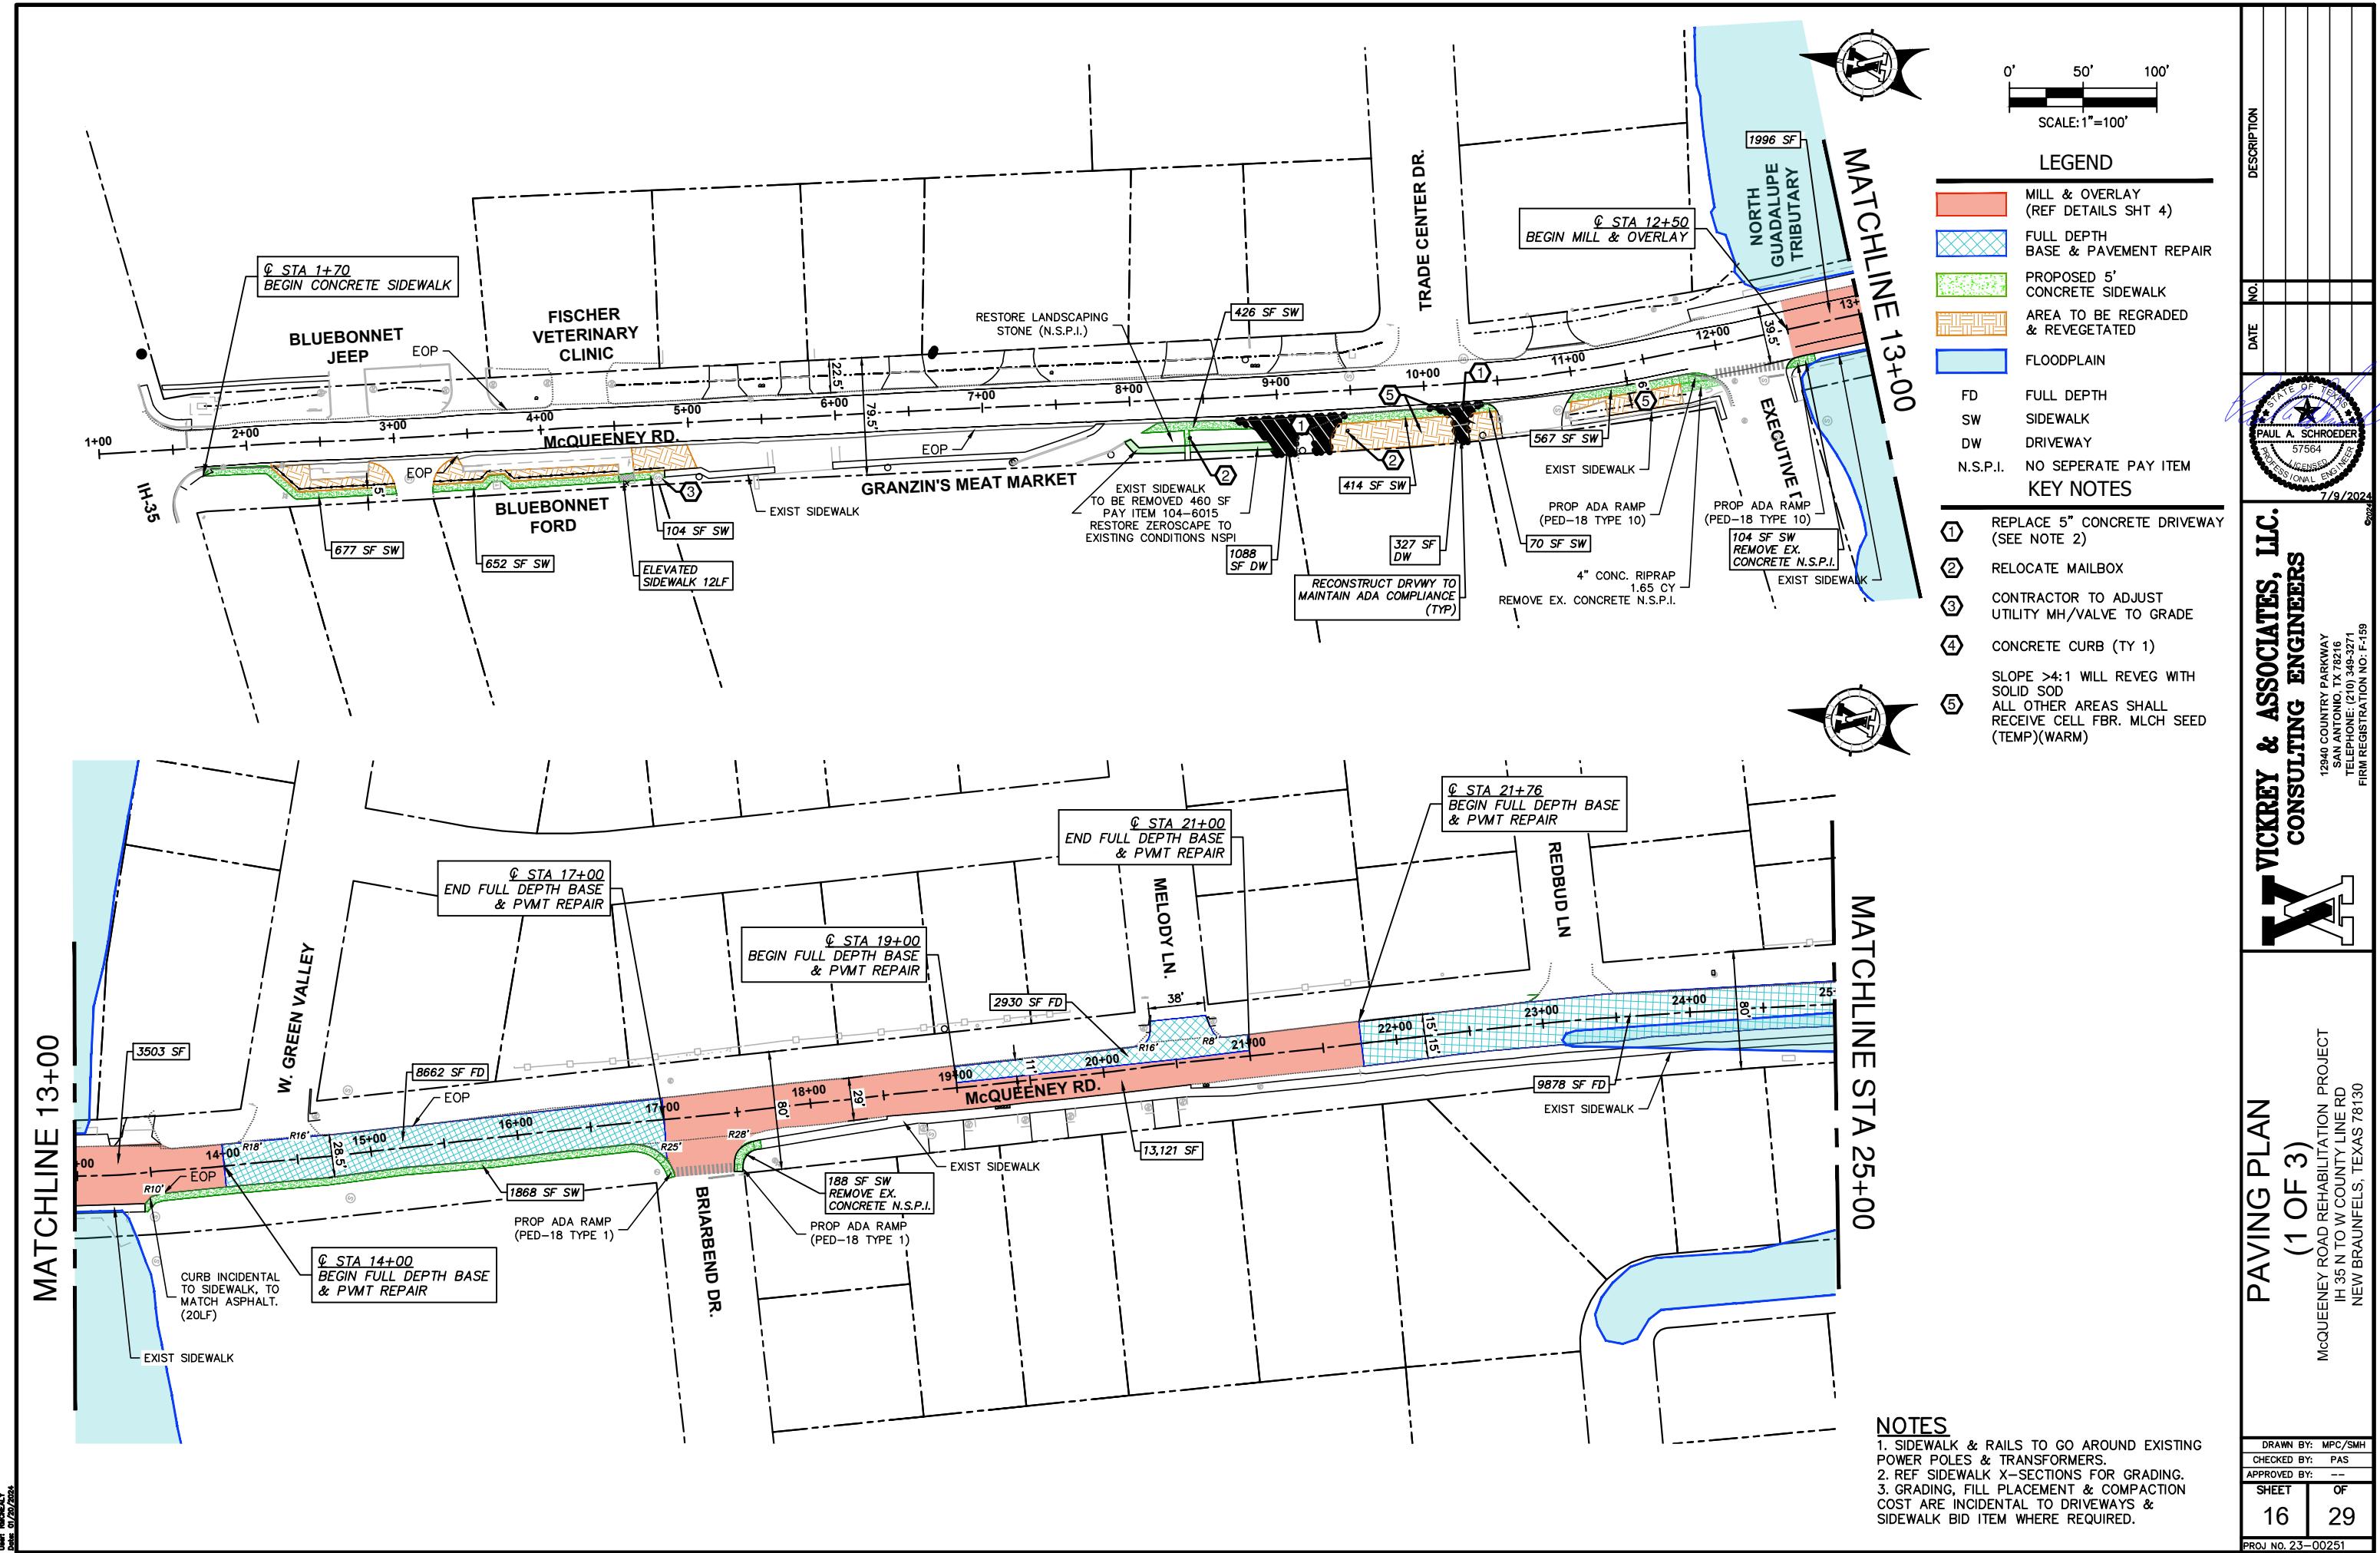

## SECTION A-A PROP ROAD OVER CULVERT BRIDGE

NOT TO SCALE

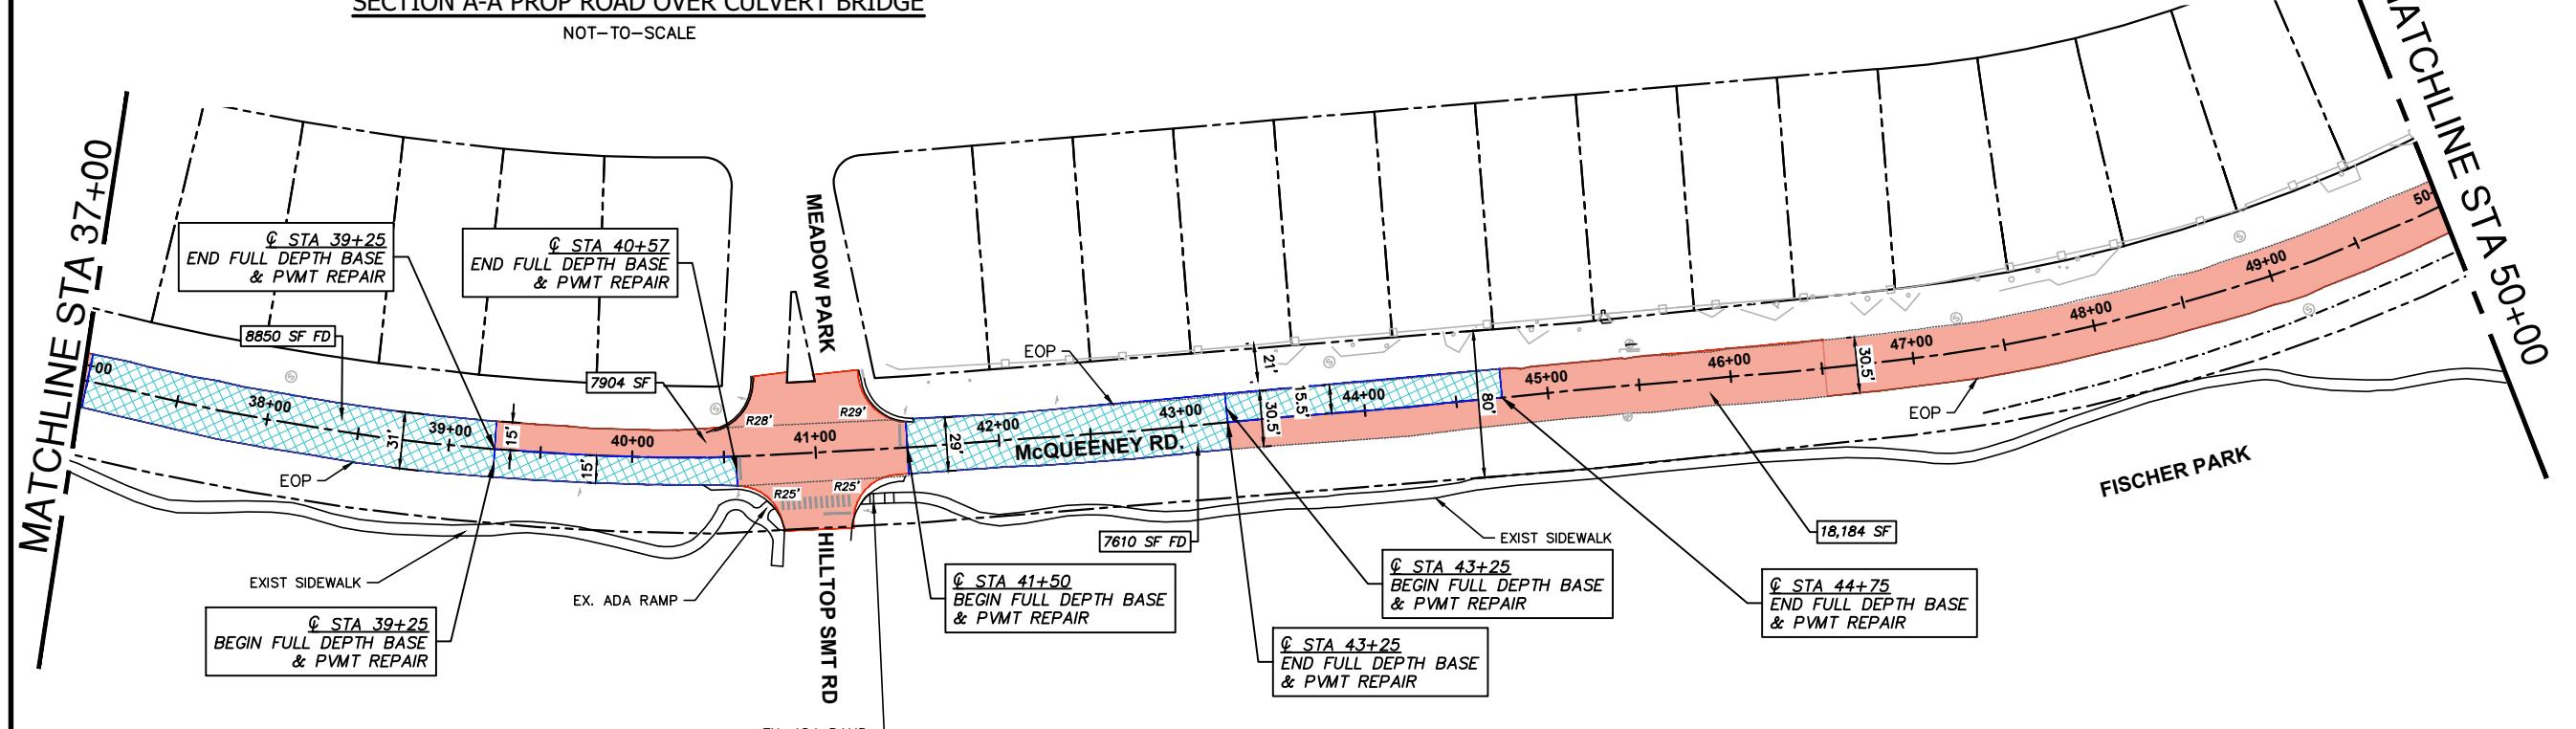

KREY & ASSOCIATES, LLC.  
CONSULTING ENGINEERS

12940 COUNTRY PARKWAY  
SAN ANTONIO, TX 78216  
TELEPHONE: (210) 349-3271  
IRM REGISTRATION NO: F-159

1/2 QUEENEY ROAD REHABILITATION PROJECT  
IH 35 N TO W COUNTY LINE RD  
NEW BRAUNFELS, TEXAS 78130

SAVING PLAN  
(2 OF 3)


McQUEENEY  
IH 35  
NEW B

Y: MPC/SMH  
Y: PAS  
Y: --  
OF  
29

-00251

## OTES

**SIDEWALK & RAILS TO GO AROUND EXISTING  
POWER POLES & TRANSFORMERS.  
REF SIDEWALK X-SECTIONS FOR GRADING.  
GRADING, FILL PLACEMENT & COMPACTION  
ITEMS ARE INCIDENTAL TO DRIVEWAYS &  
WALKWAY BID ITEM WHERE REQUIRED.**

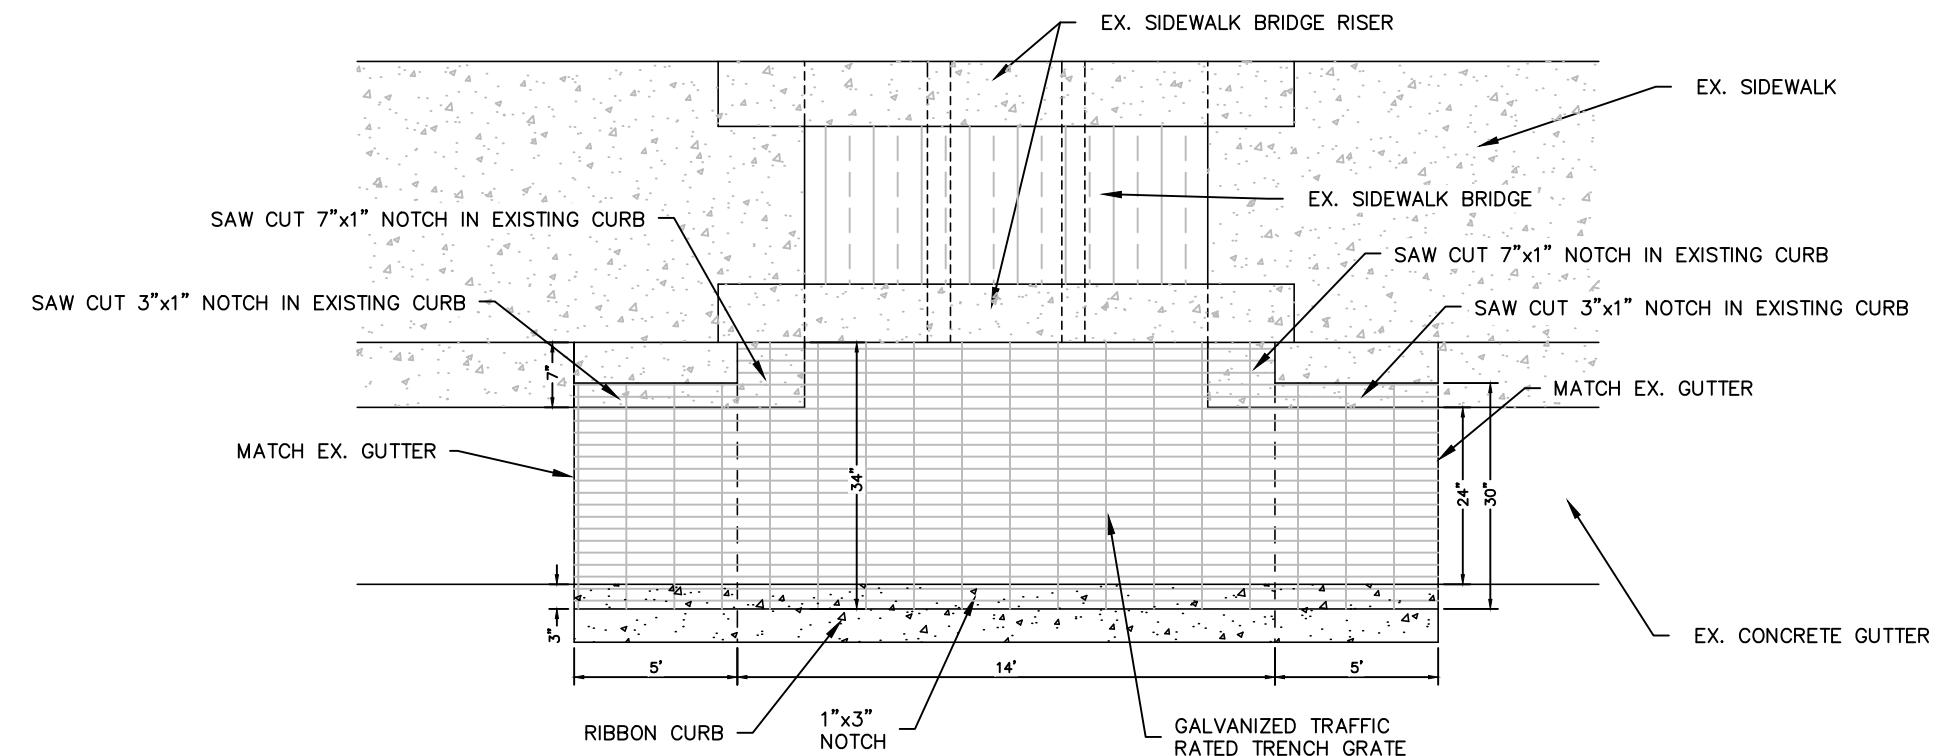


**DETAIL A - PLAN VIEW**

NOT-TO-SCALE

**VICKREY & ASSOCIATES, LLC.**  
**CONSULTING ENGINEERS**

12940 COUNTRY PARKWAY  
SAN ANTONIO, TX 78216  
TELEPHONE: (210) 349-3271  
FIRM REGISTRATION NO: F-159

**DETAIL A**  
McQUEENEY ROAD REHABILITATION PROJECT  
IH 35 NORTH COUNTY LINE RD  
NEW BRAUNFELS, TEXAS 78130

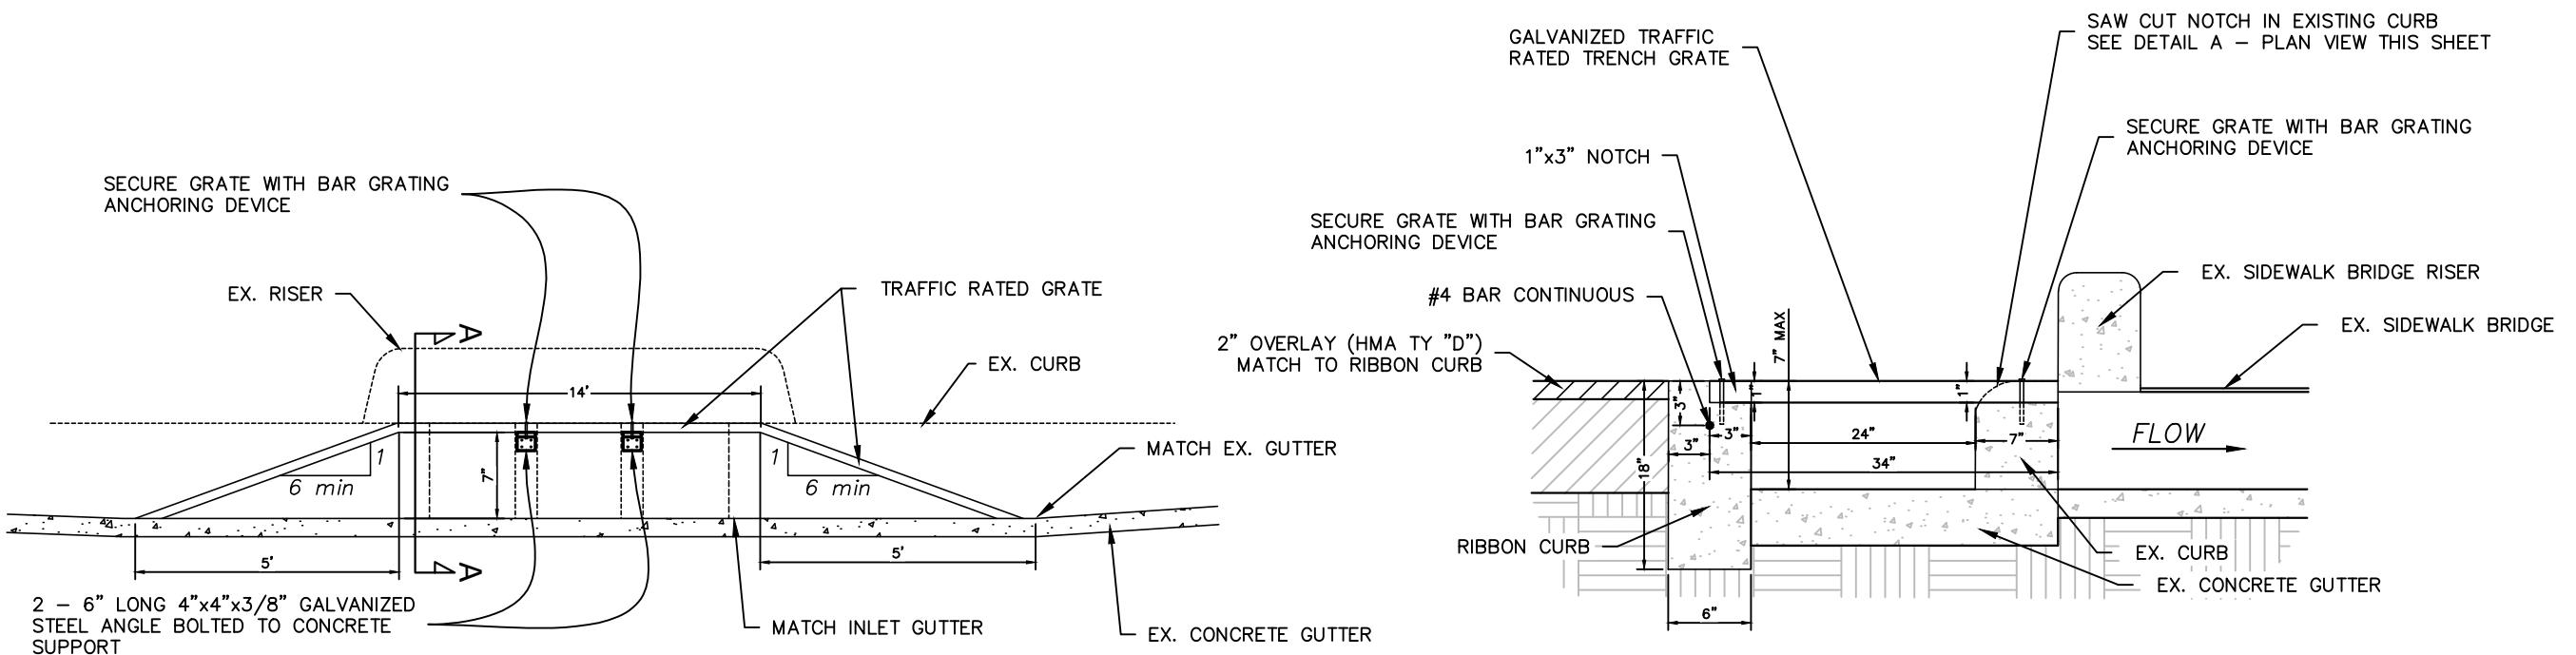

**DETAIL A - PROFILE VIEW**

NOT-TO-SCALE


**SECTION B-B**

NOT-TO-SCALE

**NOTES**

1. SIDEWALK & RAILS TO GO AROUND EXISTING POWER POLES & TRANSFORMERS.
2. REF SIDEWALK X-SECTIONS FOR GRADING.
3. GRADING, FILL PLACEMENT & COMPACTION COST ARE INCIDENTAL TO DRIVEWAYS & SIDEWALK BID ITEM WHERE REQUIRED.

DRAWN BY: MPC/SMH  
CHECKED BY: PAS  
APPROVED BY: ---  
SHEET 17-A OF 29  
PROJ NO. 23-00251

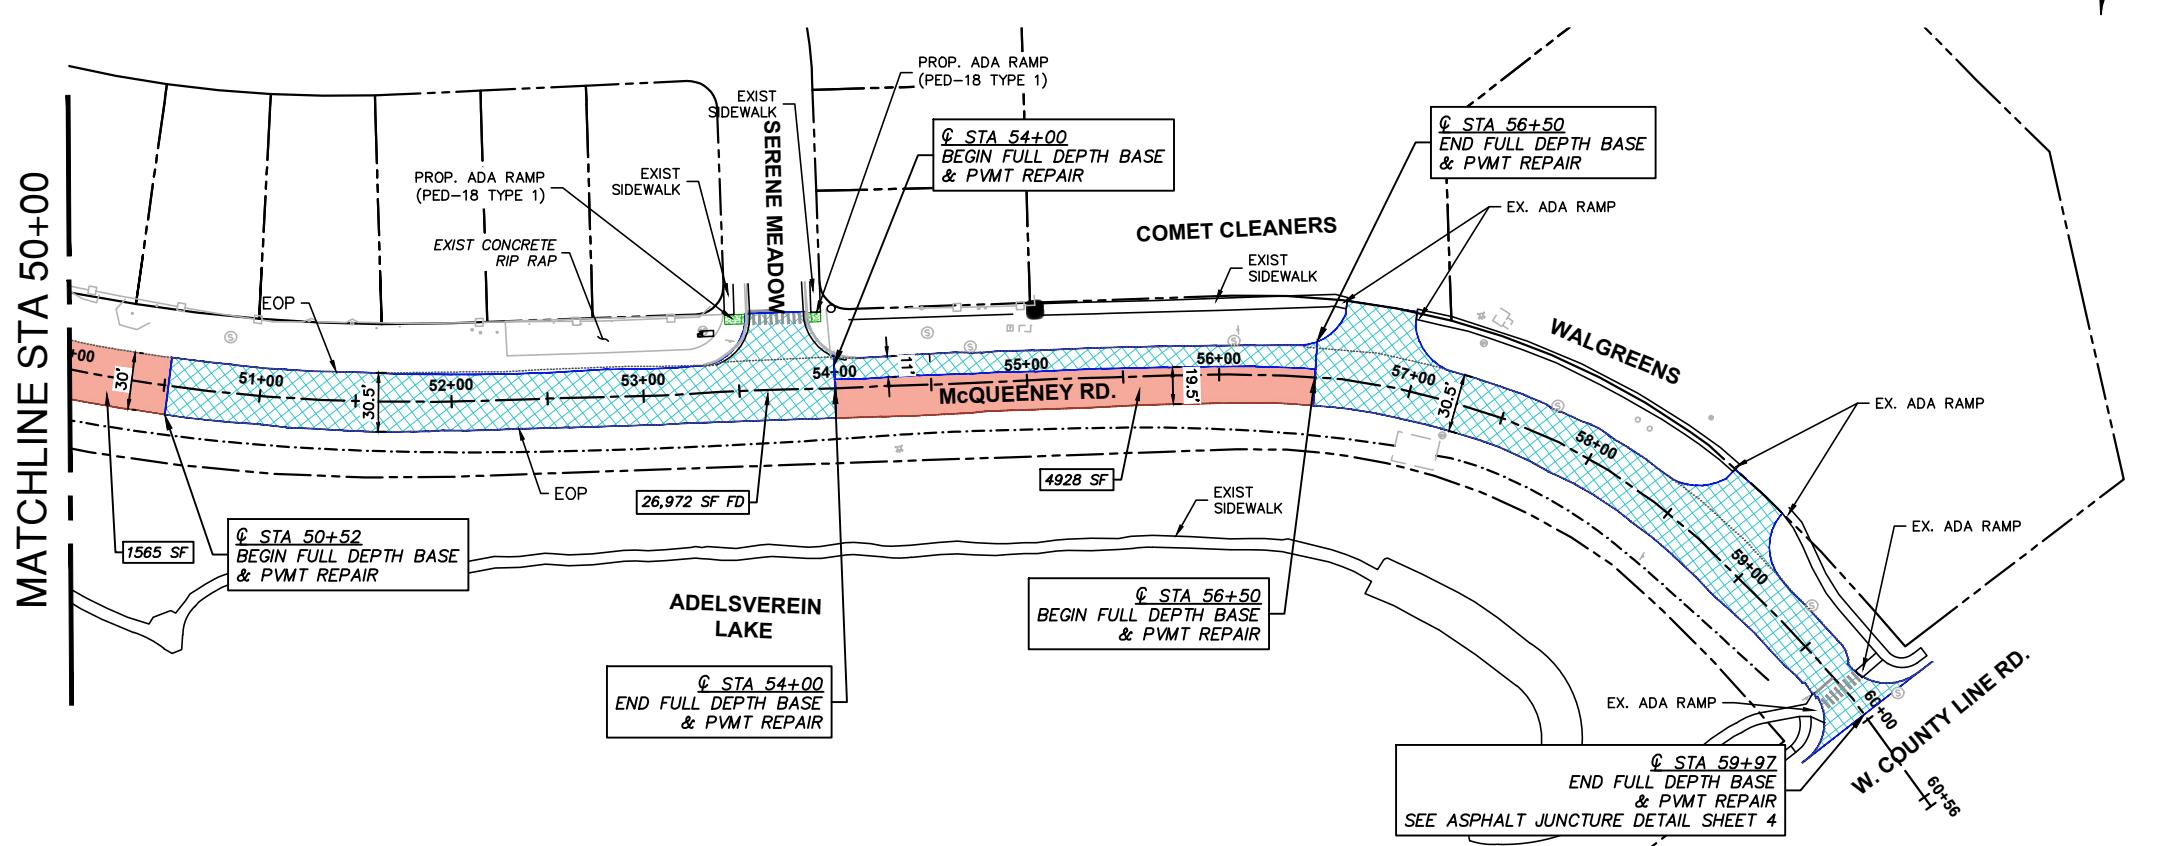

A horizontal scale bar with two vertical tick marks. The first tick mark is labeled '50' above the bar. The second tick mark is labeled '100' above the bar. Below the bar, the text 'SCALE: 1"=100'' is written.

## LEGEND

	MILL & OVERLAY (REF DETAILS SHT 4)
	FULL DEPTH BASE & PAVEMENT REPAIR
	PROPOSED 5' CONCRETE SIDEWALK
	AREA TO BE REGRADED & REVEGETATED
FD	FULL DEPTH
SW	SIDEWALK
DW	DRIVeway

A circular seal for a professional engineer. The outer ring contains the text "STATE OF TEXAS" at the top and "PROFESSIONAL ENGINEER" at the bottom. The inner circle contains "PAUL A. SCHROEDER" in the center, with "57564" below it. At the bottom of the inner circle is the date "7/9/2024". The entire seal is framed by a decorative border.

## KEY NOTES



- REPLACE 5" CONCRETE DRIVEWAY  
(SEE NOTE 2)
- RELOCATE MAILBOX
- CONTRACTOR TO ADJUST  
UTILITY MH/VALVE TO GRADE
- CONCRETE CURB (TY 1)
- SLOPE >4:1 WILL REVEG WITH  
SOLID SOD  
ALL OTHER AREAS SHALL  
RECEIVE CELL FBR. MLCH SEED  
(TEMP)(WARM)

**(3 OF 3)**  
I-35/QUEENEY ROAD REHABILITATION PROJECT  
IH 35 N TO W COUNTY LINE RD  
NEW BRAUNFELS, TEXAS 78130

**ULTING ENGINE**  
12940 COUNTRY PARKWAY  
SAN ANTONIO, TX 78216  
TELEPHONE: (210) 349-3271  
IRM REGISTRATION NO: F-159

AWN BY: MPC/SMH  
CKED BY: PAS  
VED BY: --  
EET OF  
8 29  
no. 23-00251

OTES  
SIDEWALK & RAILS TO GO AROUND EXISTING  
POWER POLES & TRANSFORMERS.  
REF SIDEWALK X-SECTIONS FOR GRADING,  
GRADING, FILL PLACEMENT & COMPACTION  
TESTS ARE INCIDENTAL TO DRIVEWAYS &  
NEWWALK BID ITEM WHERE REQUIRED.

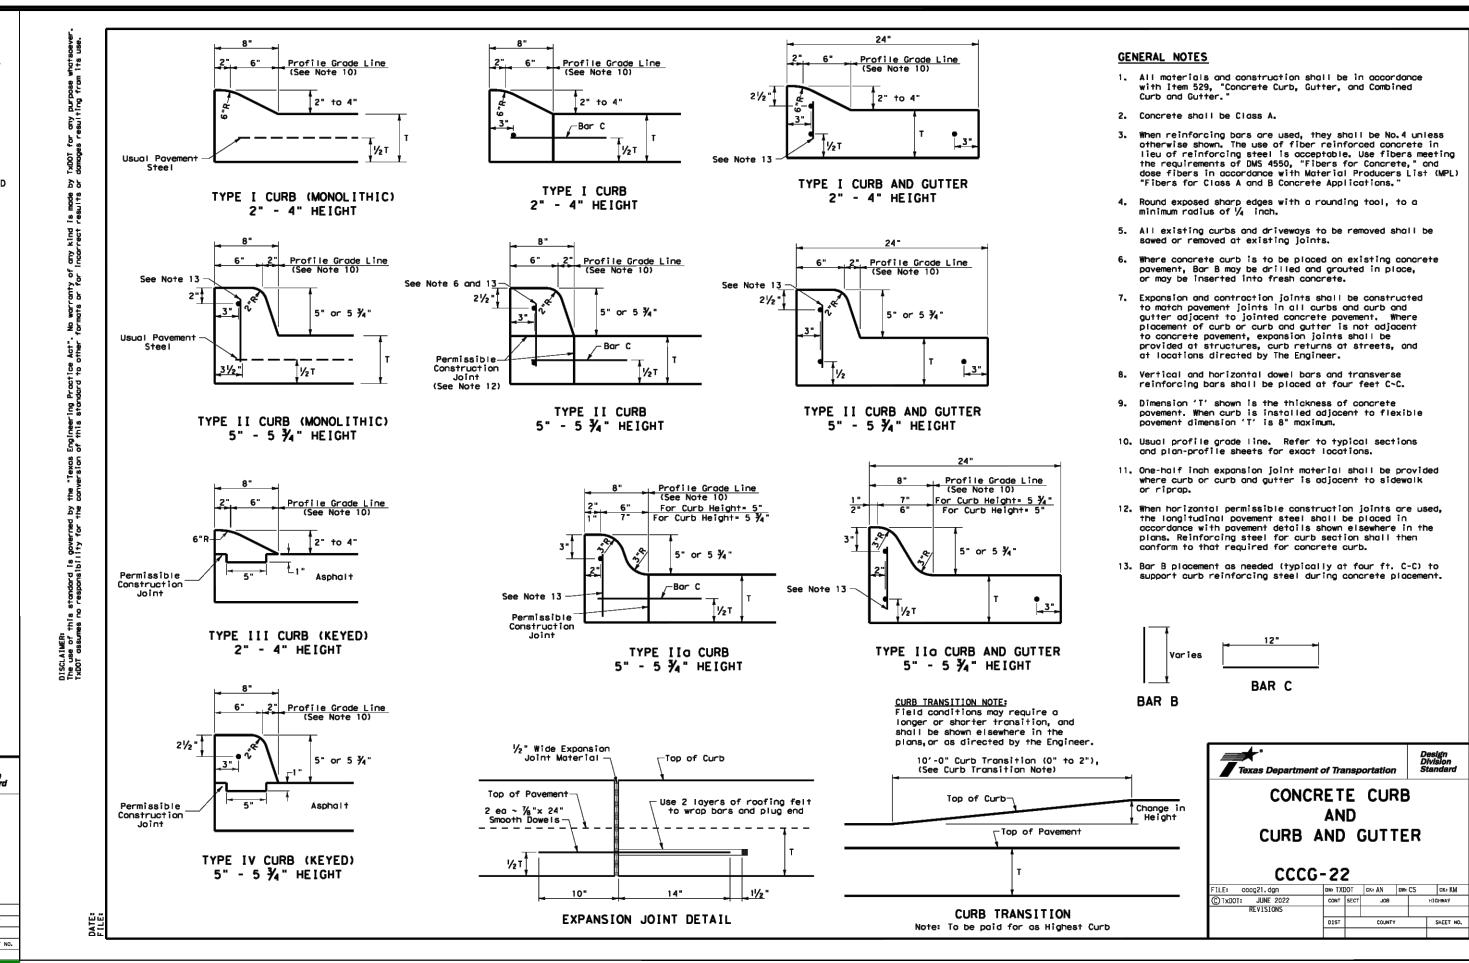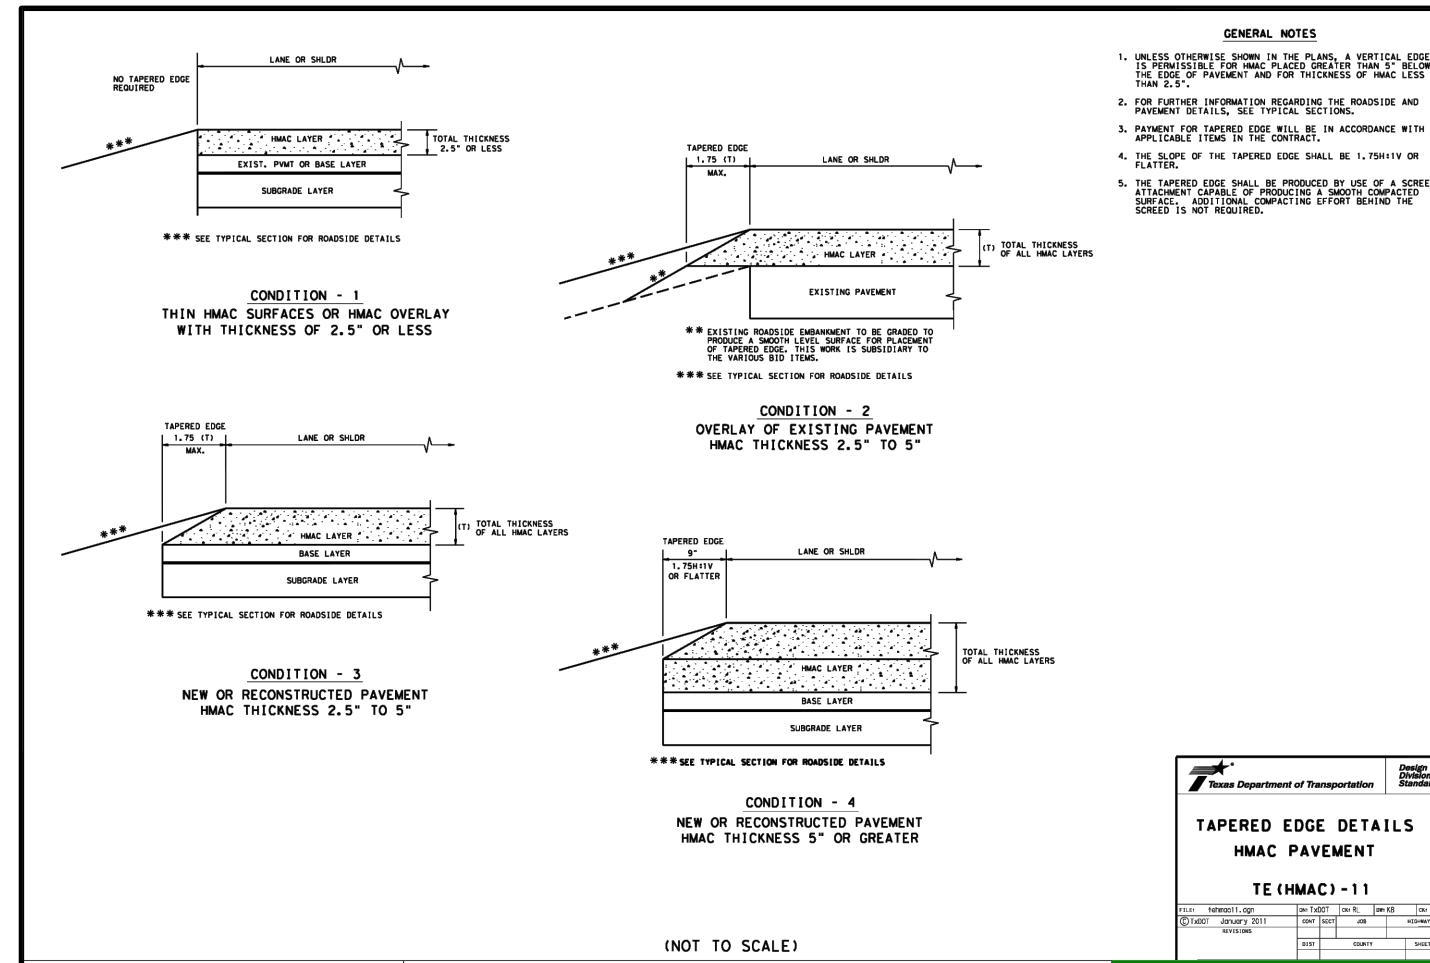


GENERAL NOTES	
1. All materials and construction shall be in accordance with Item 529, "Concrete Curb, Custer, and Combined Curb and Gutter."	
2. Concrete shall be Class A.	
3. When reinforcing bars are used, they shall be No. 4 unless otherwise shown. The use of fiber reinforced concrete in the use of reinforcing steel is acceptable. Use fibers meeting the requirements of Item 550, "Fiber for Concrete," and do fibers in accordance with Material Producers List (MPL) "Fiber for Class A and B Concrete Applications."	
4. Round exposed sharp edges with a rounding tool, to a minimum radius of $\frac{1}{8}$ inch.	
5. All existing curb and driveways to be removed shall be saved or removed of existing joints.	
6. Where concrete curb is to be placed on existing concrete curb, the existing curb and ground in place, or may be inserted into fresh concrete.	
7. Expansion and contraction joints shall be constructed to match pavement joints in all curbs and curb and gutter adjacent to joined concrete pavement. Where placed in concrete, the curb and gutter shall be adjacent to concrete pavement; expansion joints shall be provided for structures, curb returns or streets, and at locations directed by the Engineer.	
8. Vertical and horizontal dowel bars and transverse reinforcing bars shall be placed at your feet C-C.	
9. Dimension "T" shown is the thickness of concrete pavement. When curb is installed adjacent to flexible pavement dimension "T" is 8" maximum.	
10. Usual profile grade line. Refer to typical sections and plan-profile sheets for exact locations.	
11. Vertical profile grade line. Refer to typical sections and plan-profile sheets for exact locations.	
12. Permissible construction joints are used, the longitudinal pavement joints shall be placed in accordance with pavement details shown elsewhere in the plans. Reinforcing steel for curb section shall then conform to that required for concrete curb.	
13. Bar B placement as needed (typically at four ft. C-C) to support curb reinforcing steel during concrete placement.	

**Texas Department of Transportation**  
Design Division Standard  
**CONCRETE CURB AND CURB AND GUTTER**  
CCCG-22


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DATE: 1/20/2012  
REV: 001  
CITY: SAN ANTONIO, TX 78216  
FIRM REGISTRATION NO: F-159

**PAVING DETAILS**  
McQUEENEY ROAD REHABILITATION PROJECT  
IH 35 NORTH COUNTY LINE RD  
NEW BRAUNFELS, TEXAS 78130


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FIRM REGISTRATION NO: F-159

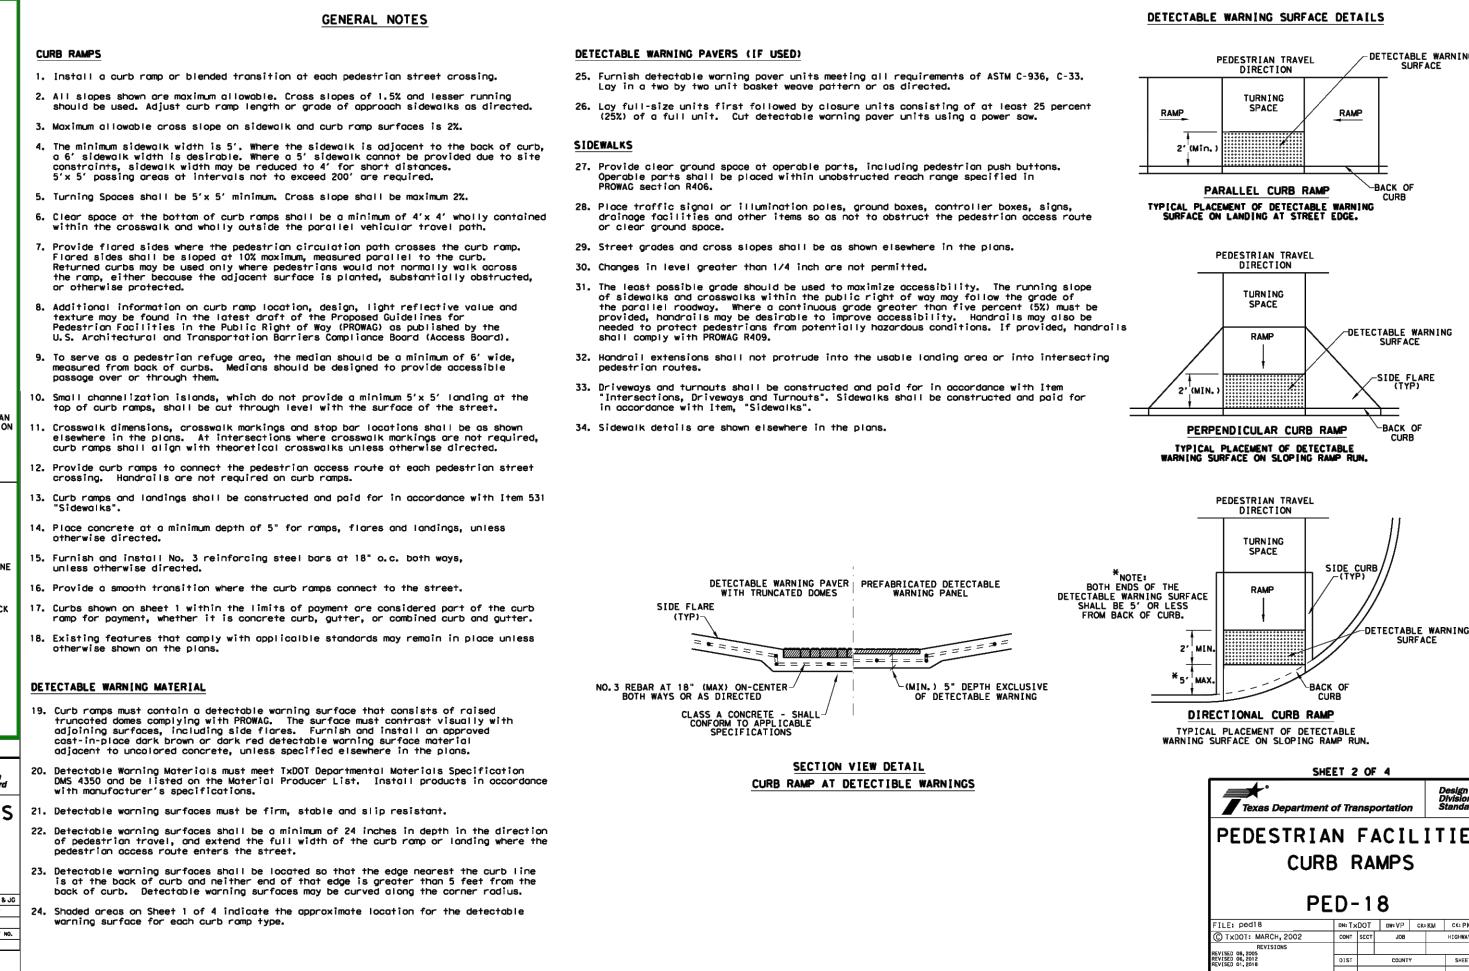



DRAWN BY: MPC/SMH  
CHECKED BY: PAS  
APPROVED BY: ---  
SHEET 19 OF 29  
PROJ. NO. 23-00251

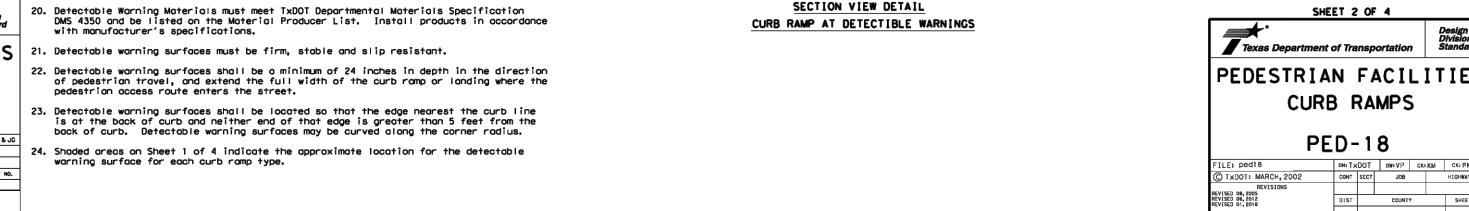

SHEET 20 OF 4  
PROJ. NO. 23-00251

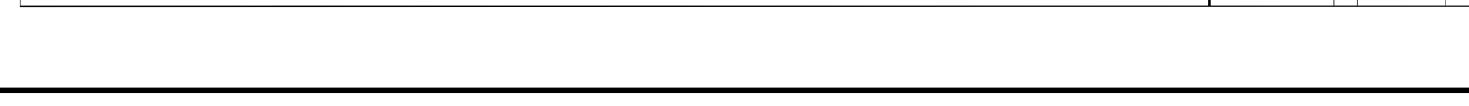


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CHECKED BY: PAS  
APPROVED BY: ---  
SHEET 19 OF 29  
PROJ. NO. 23-00251

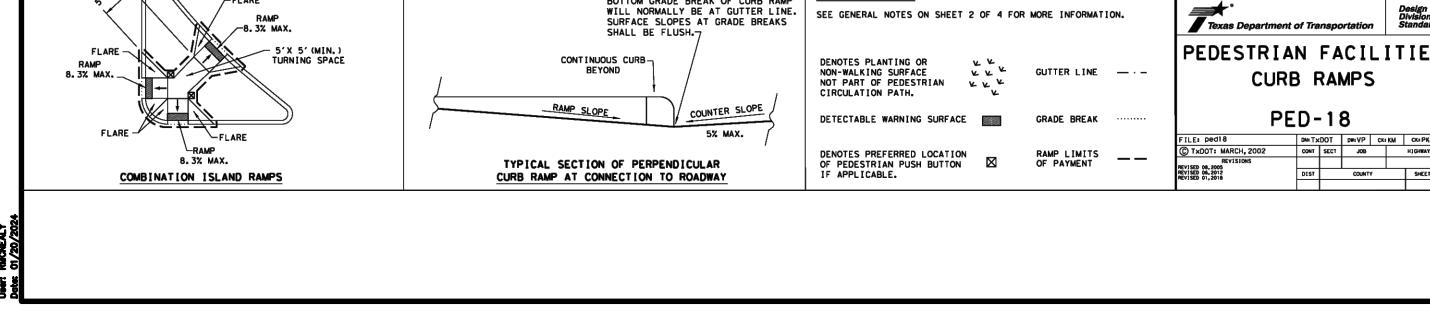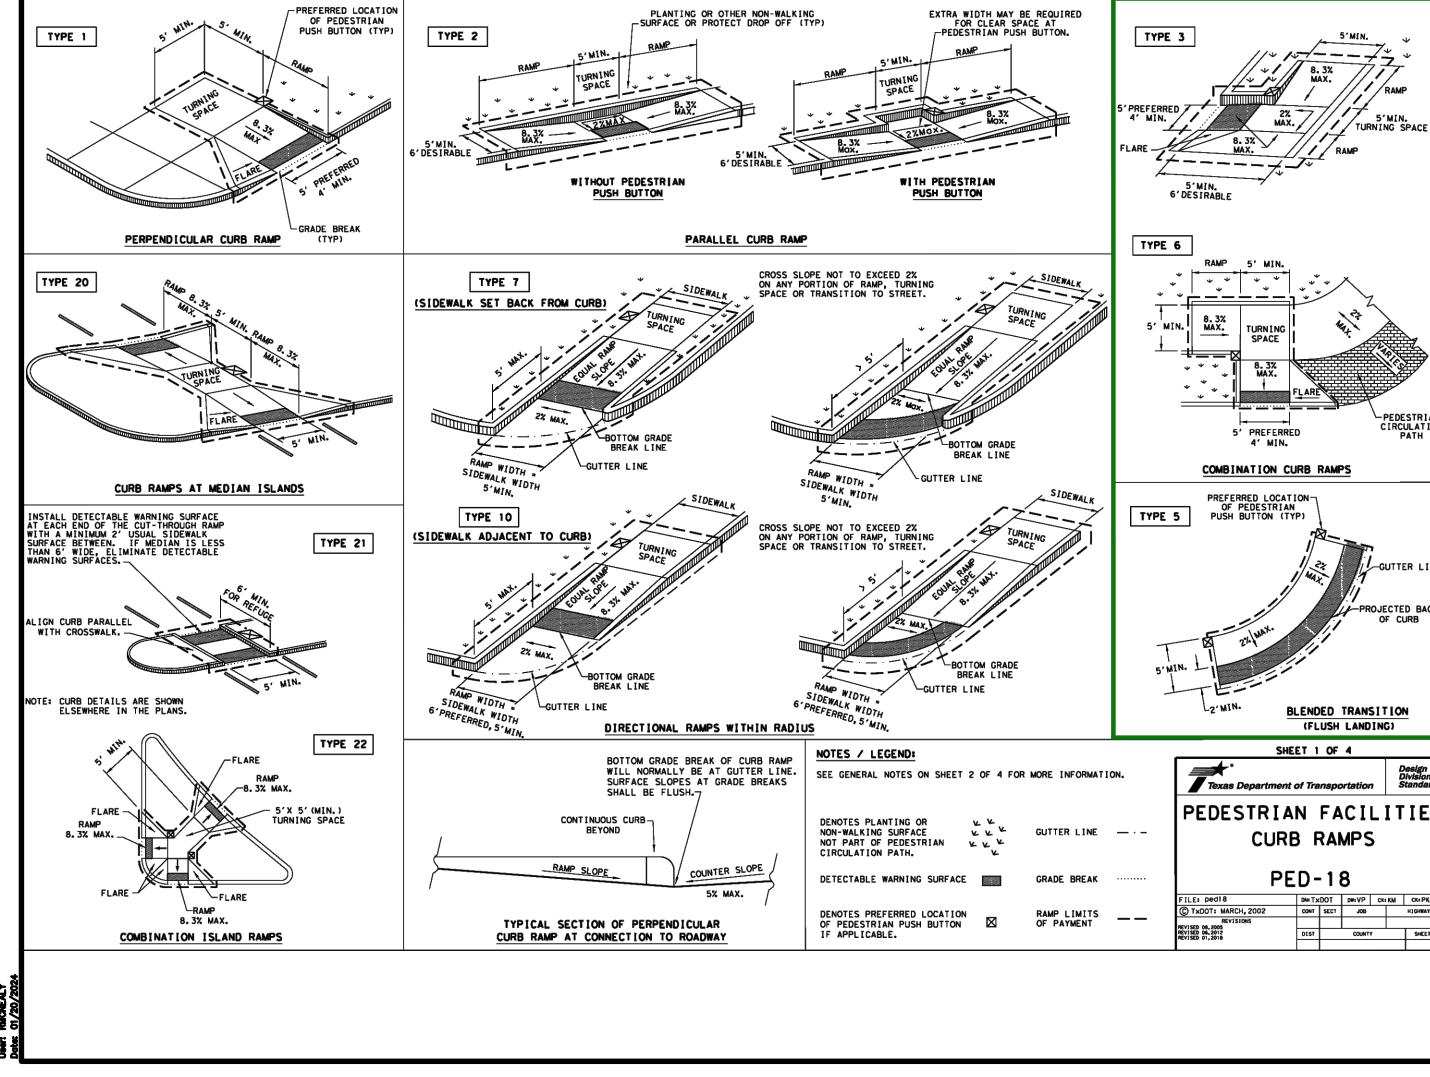

SHEET 20 OF 4  
PROJ. NO. 23-00251



0' 50' 100'  
SCALE: 1"=100'

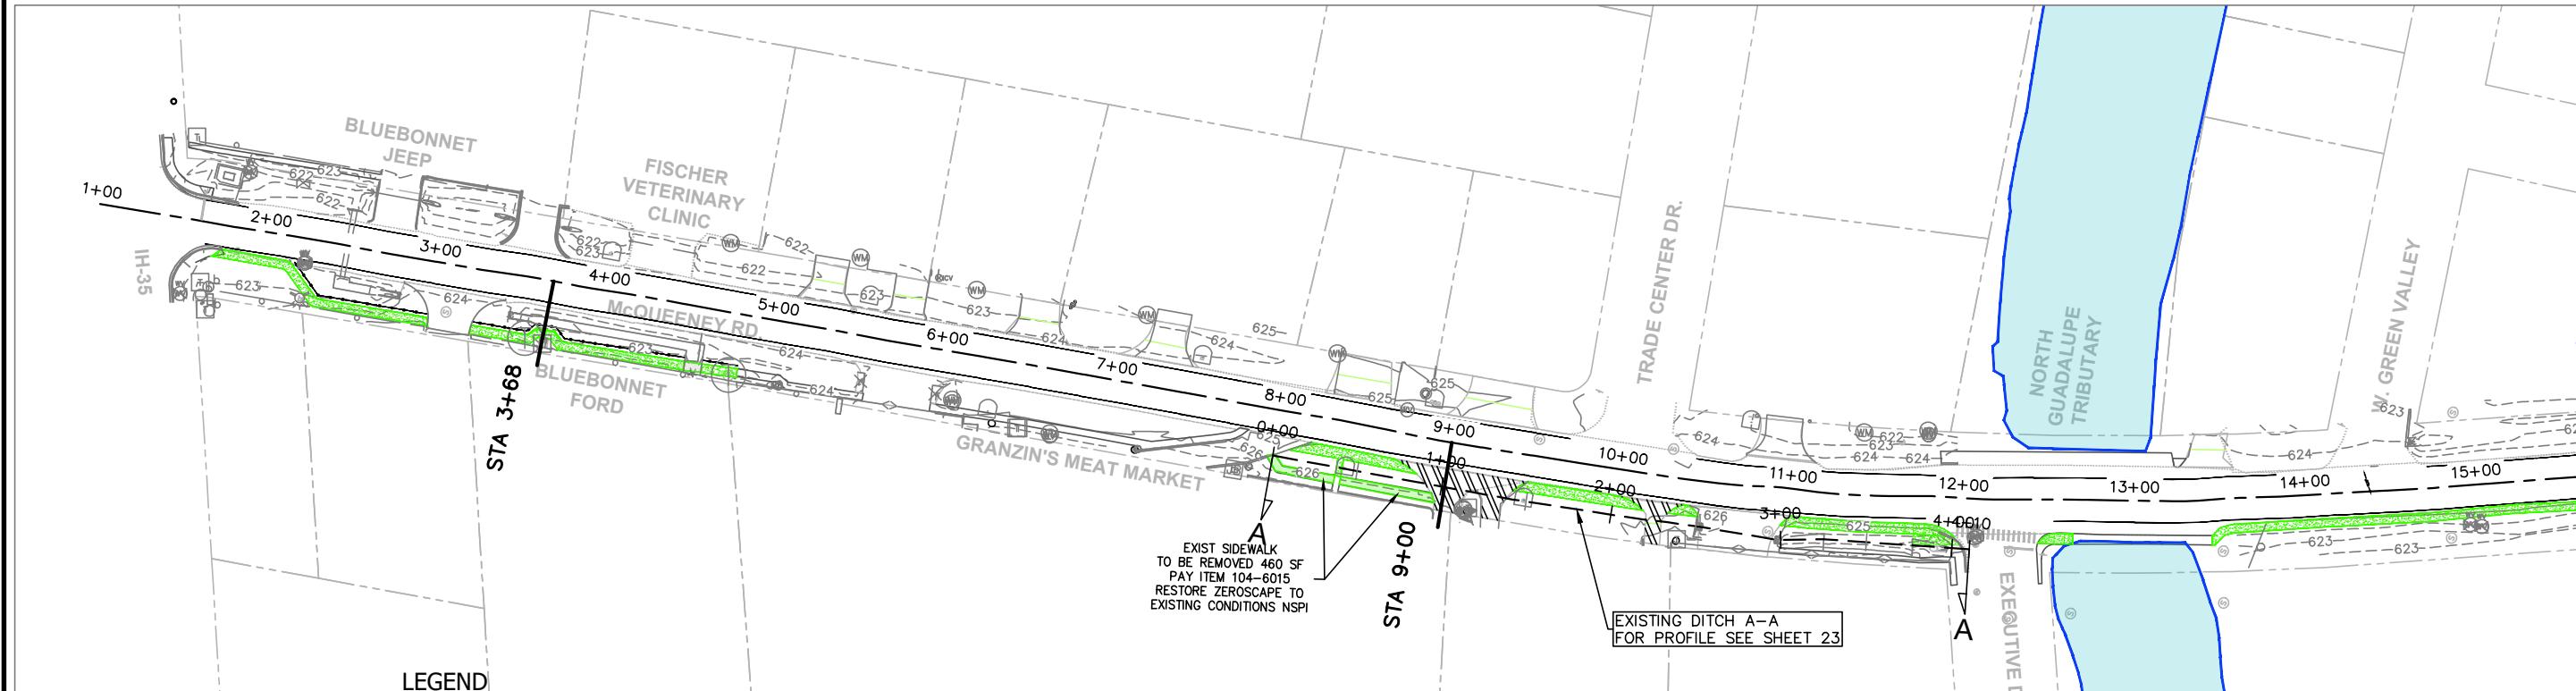




**VICKREY & ASSOCIATES, LLC.**  
CONSULTING ENGINEERS

12940 COUNTRY PARKWAY  
SAN ANTONIO, TX 78216  
TELEPHONE: (210) 349-3271  
FIRM REGISTRATION NO: F-159

**OVERALL SIDEWALK PLAN (1 OF 2)**  
McQUEENEY ROAD REHABILITATION PROJECT  
IH 35 N TO COUNTY LINE RD  
NEW BRAUNFELS, TEXAS 78130

DRAWN BY: MPC/SMH  
CHECKED BY: PAS  
APPROVED BY: ---  
SHEET 20 OF 29  
PROJ. NO. 23-00251

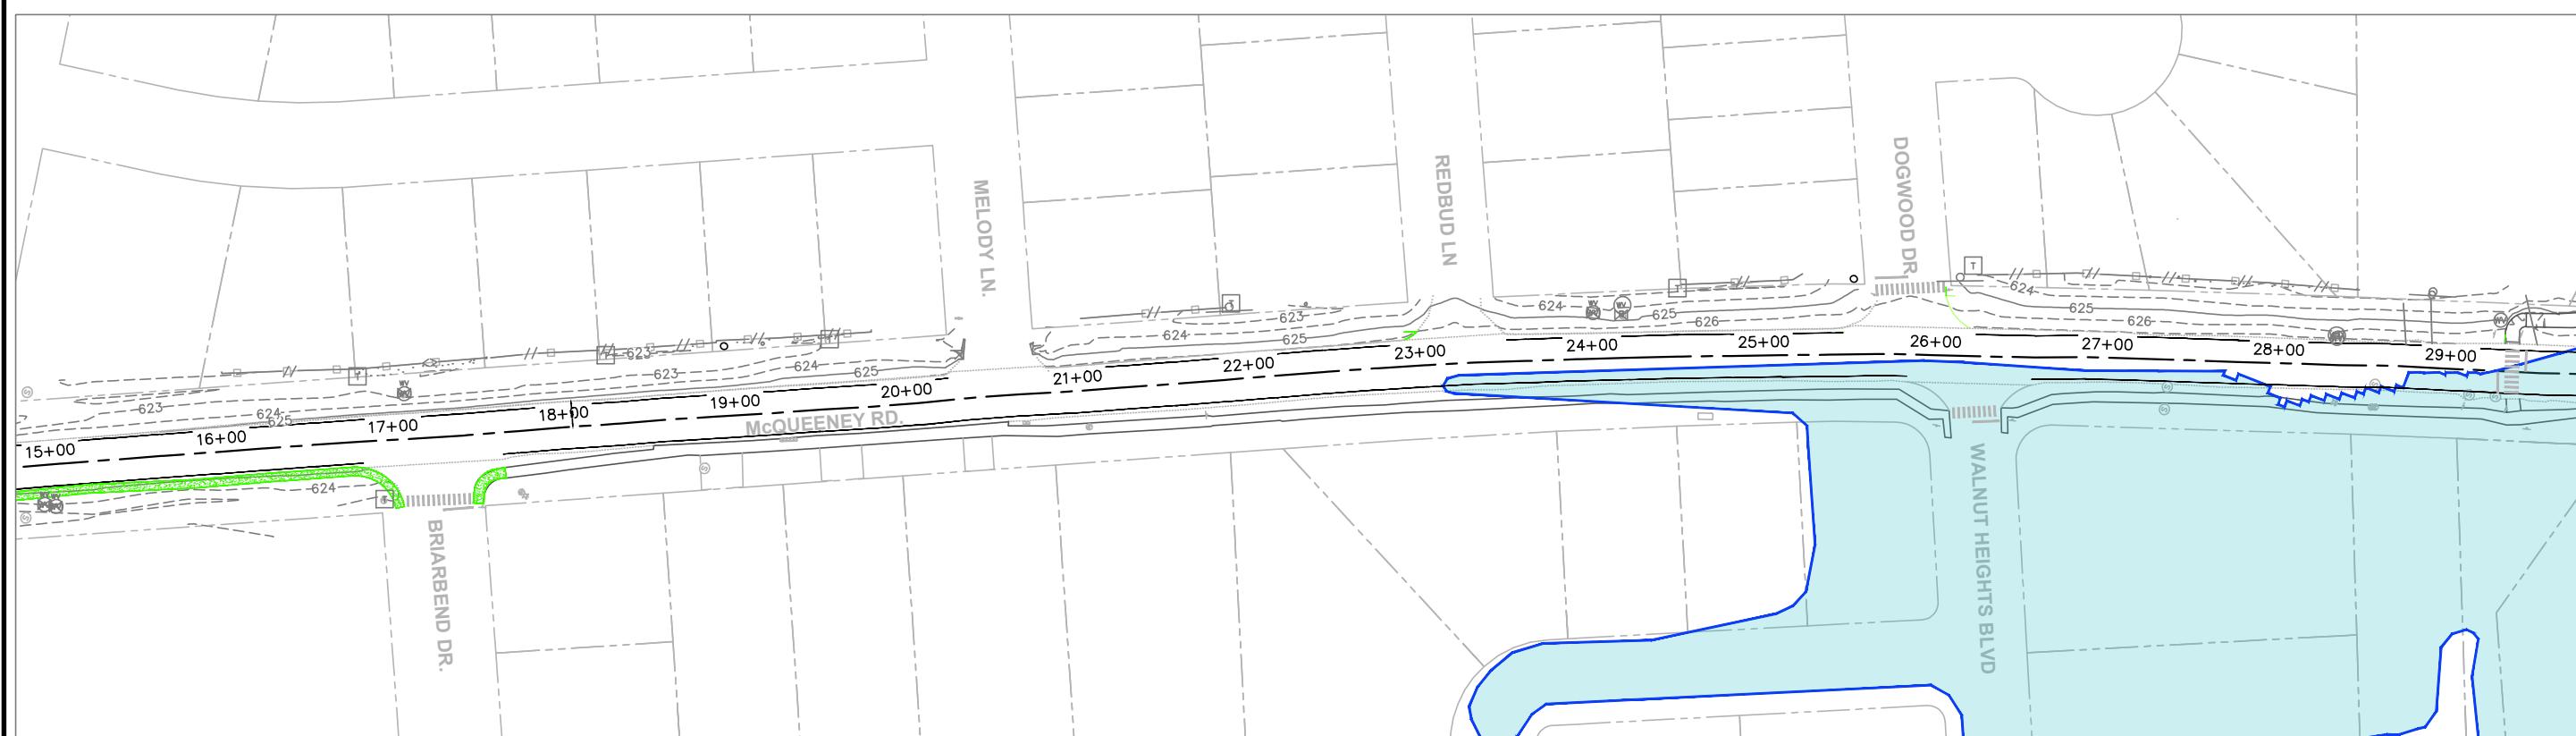

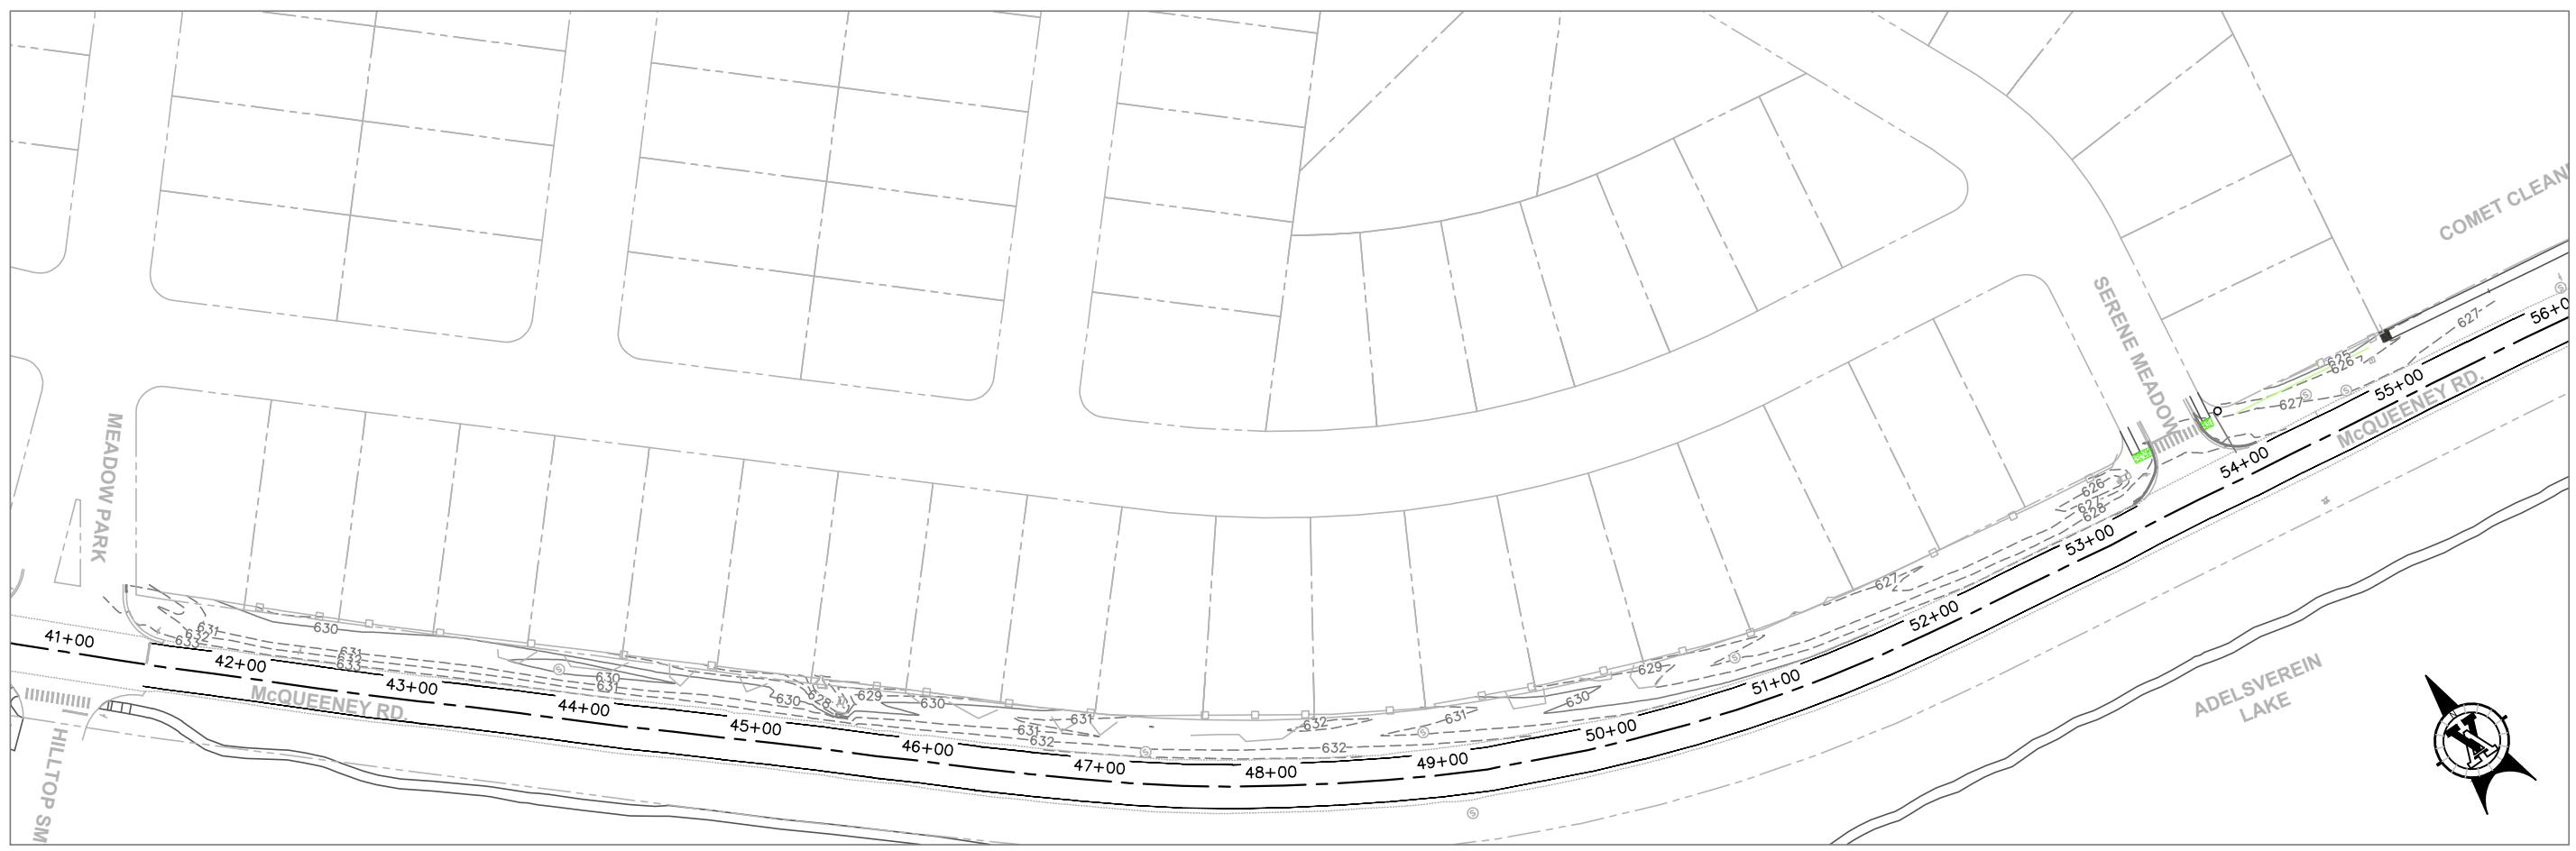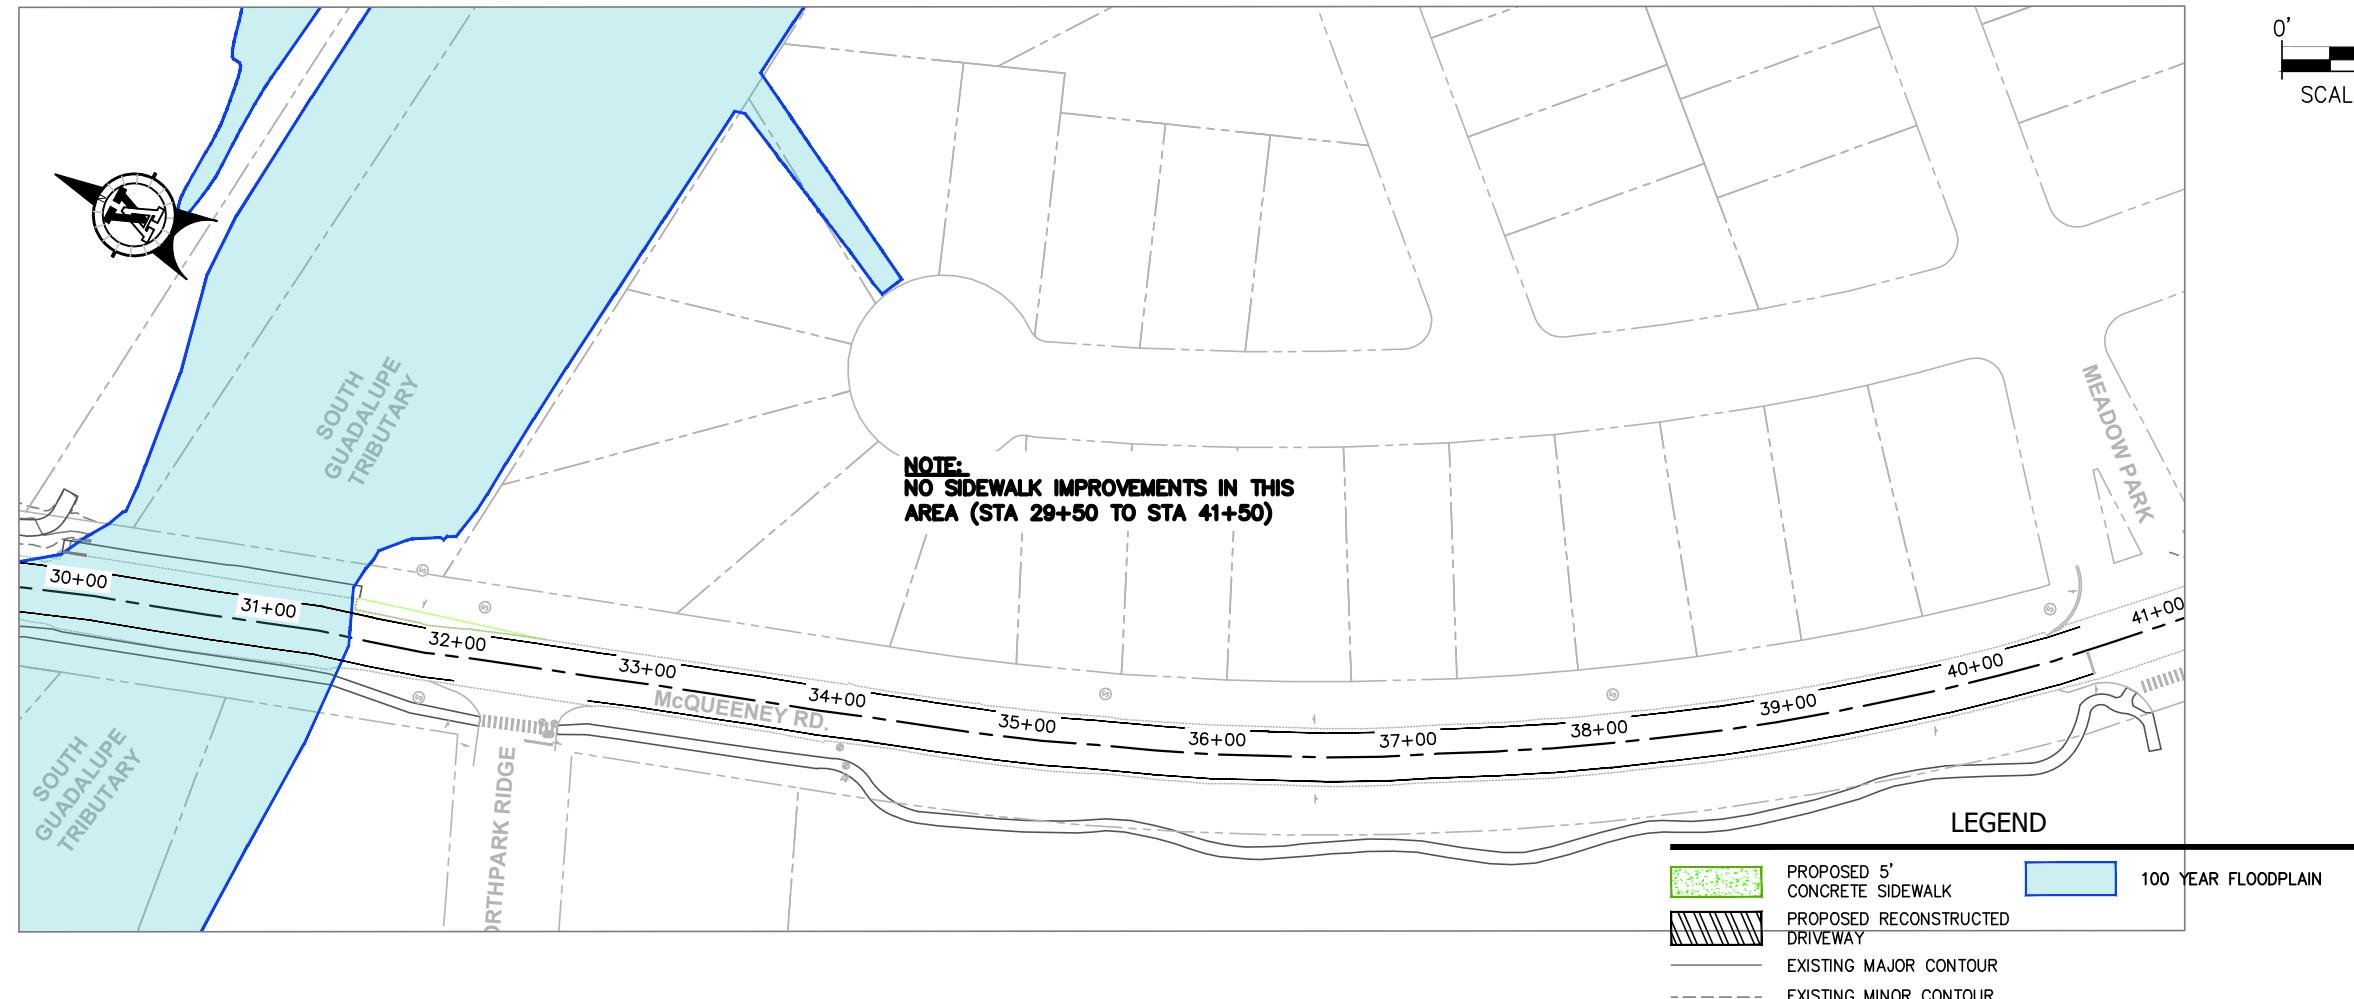

# OVERALL SIDEWALK PLAN (20E 2)

McQUEENEY ROAD REHABILITATION PROJECT  
IH 35 N TO W COUNTY LINE RD

**CKREY & ASSOCIATES, LLC.**  
CONSULTING ENGINEERS

12940 COUNTRY PARKWAY  
SAN ANTONIO, TX 78216  
TELEPHONE 210/653-2027

A watermark of the state seal of Texas, featuring a five-pointed star in the center, surrounded by a circular border with the words "THE STATE OF TEXAS".

**DESCRIPTION**

DATE	NO.	DESCRIPTION

DRAWN BY: MPC/  
CHECKED BY: PAS  
APPROVED BY: --  
SHEET OF  
21 29  
PROJ. NO. 23-00251

PROJ NO. 23-00251

0' 2' 4'  
VERT SCALE: 1"=4'  
0' 10' 20'  
HORIZ SCALE: 1"=20'

DESCRIPTION


DATE

NO.



VICKREY & ASSOCIATES, LLC.  
CONSULTING ENGINEERS



12940 COUNTRY PARKWAY  
SAN ANTONIO, TX 78216  
TELEPHONE: (210) 349-3271  
FIRM REGISTRATION NO. F-159

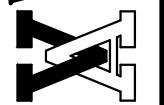

**SIDEWALK CROSS SECTIONS**

McQUEENEY ROAD REHABILITATION PROJECT  
IH 35 NORTH COUNTY LINE RD  
NEW BRAUNFELS, TEXAS 78130

DRAWN BY: MPC/SMH  
CHECKED BY: PAS  
APPROVED BY: --  
SHEET 22 OF 29  
PROJ. NO. 23-00251

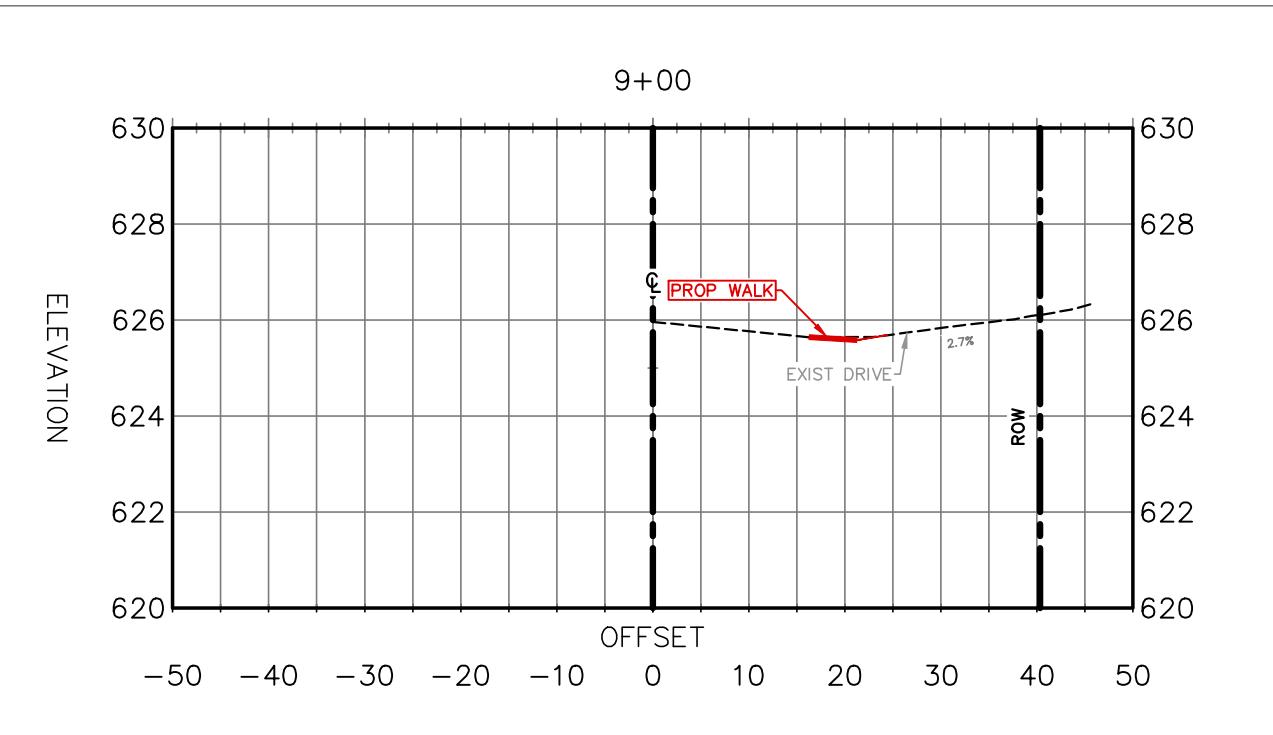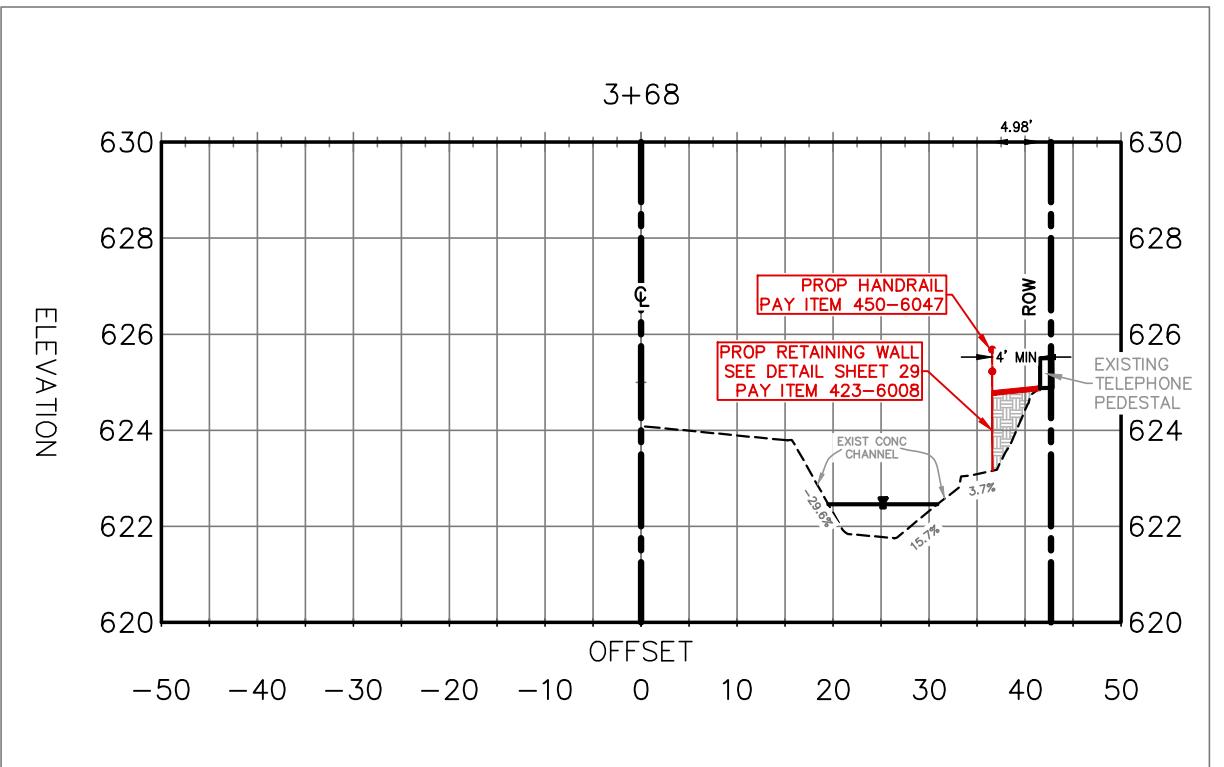


**DRAINAGE CALCULATIONS 100 YR**

**Q = 38.82 CFS  
V = 7.02 FPS  
WSE = 622.46'**

0' 2.5' 5'  
VERT SCALE: 1"=5'  
0' 25' 50'  
HORIZ SCALE: 1"=50'

## DITCH A-A PROFILE


(FOR DITCH ALIGNMENT SEE SHEET 20.)

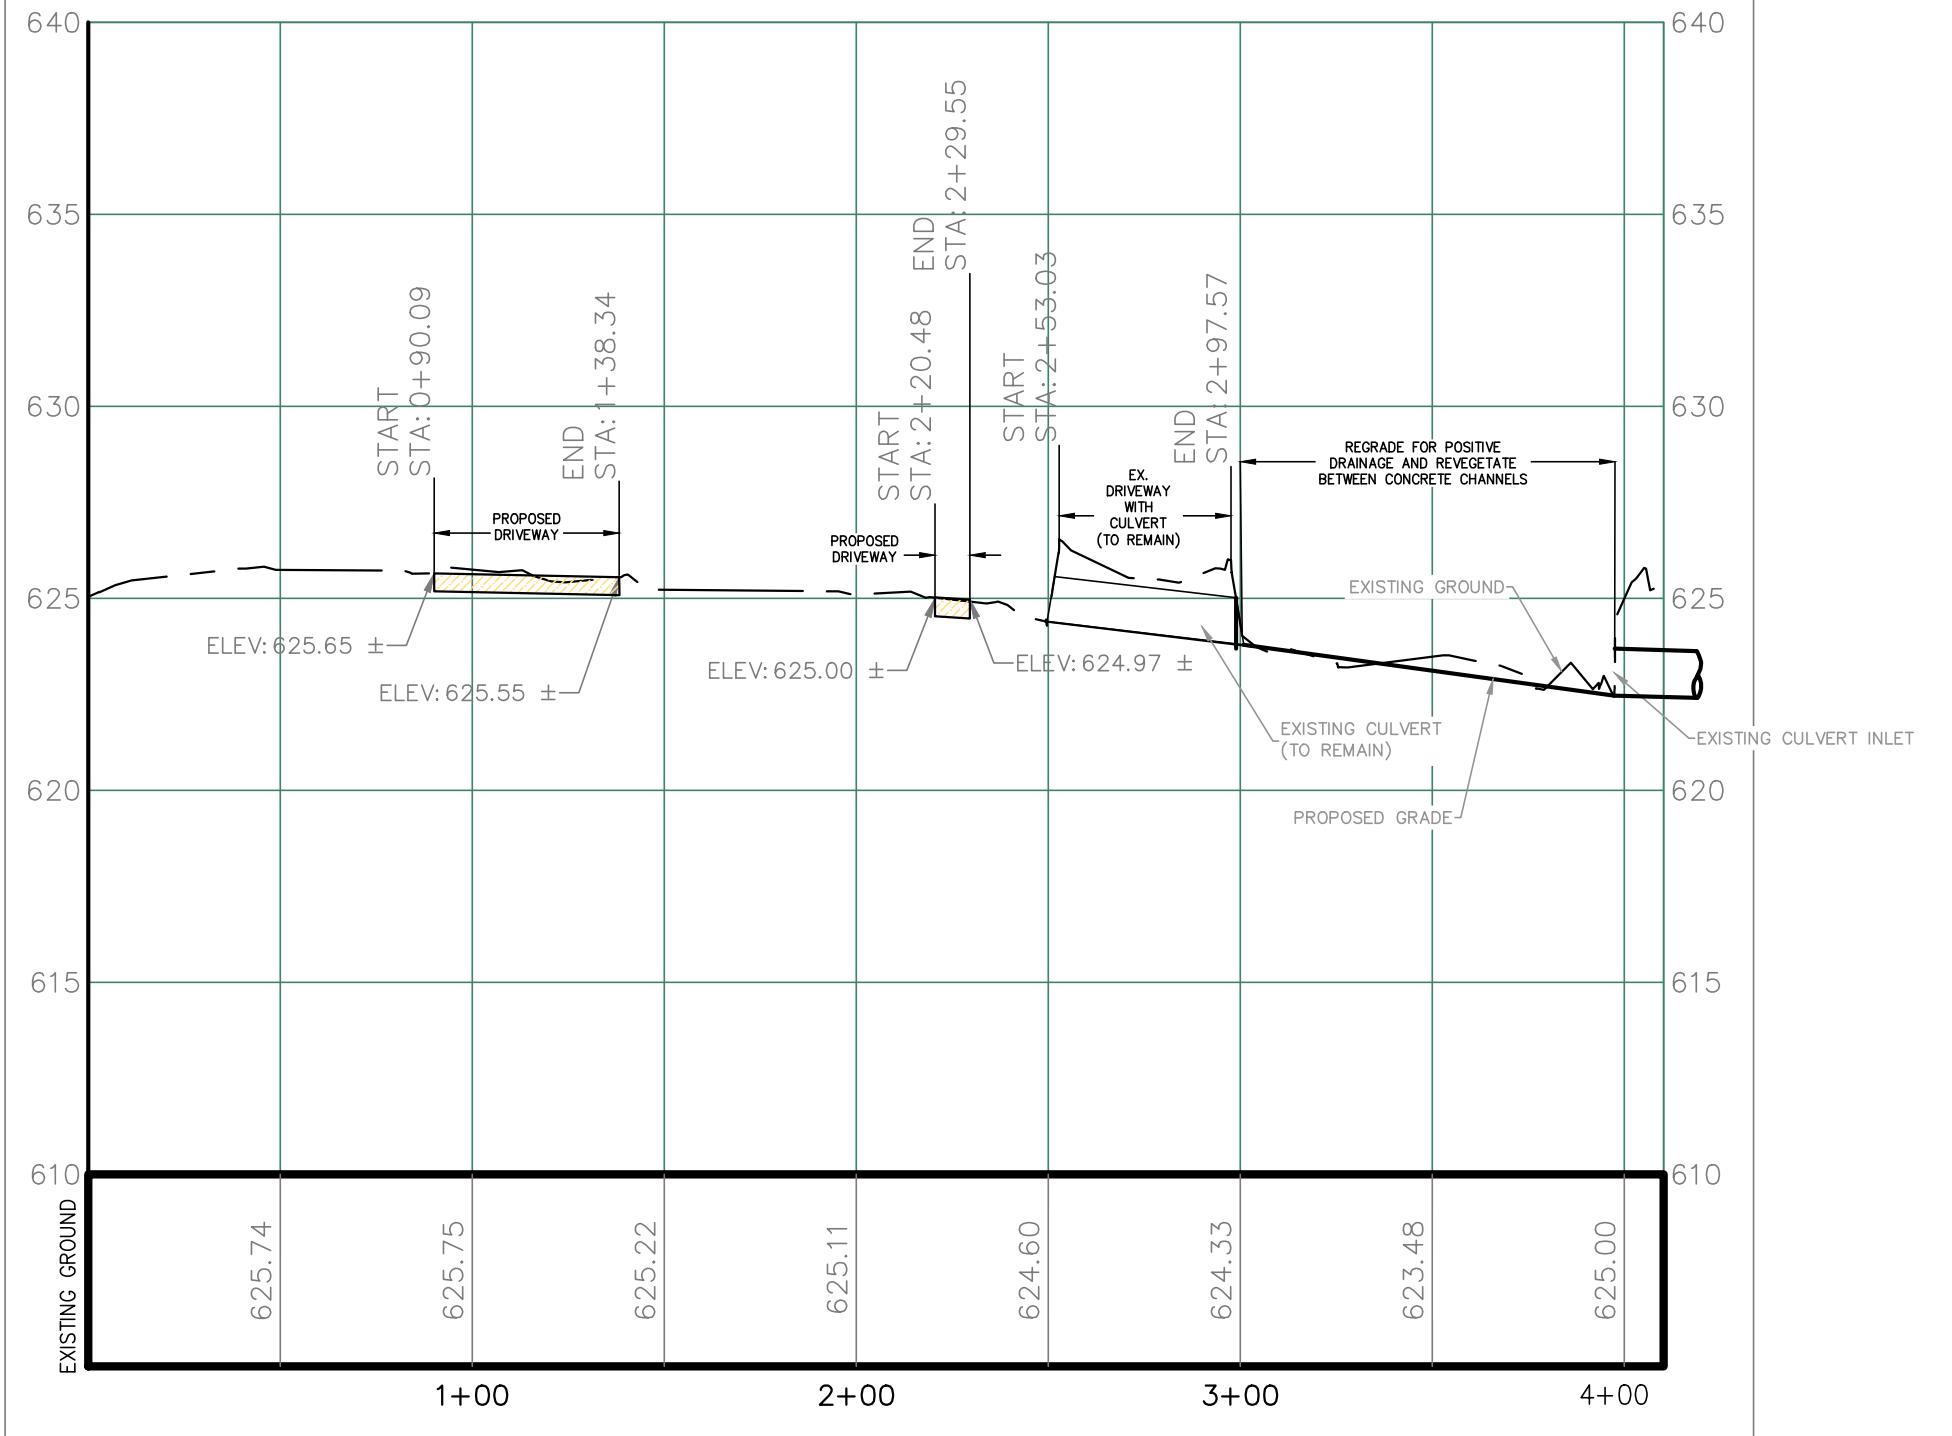

DITCH A-A PROFILE  
McQUEENEY ROAD REHABILITATION PROJECT  
IH 35 NORTH COUNTY LINE RD  
NEW BRAUNFELS, TEXAS 78130





VICKREY & ASSOCIATES, LLC.  
CONSULTING ENGINEERS

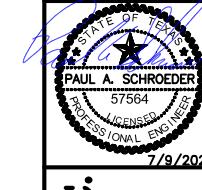

12940 COUNTRY PARKWAY  
SAN ANTONIO, TX 78216  
TELEPHONE: (210) 349-3271  
FIRM REGISTRATION NO: F-159

DRAWN BY: MPC/SMH  
CHECKED BY: PAS  
APPROVED BY: ---  
SHEET 23 OF 29  
PROJ. NO. 23-00251

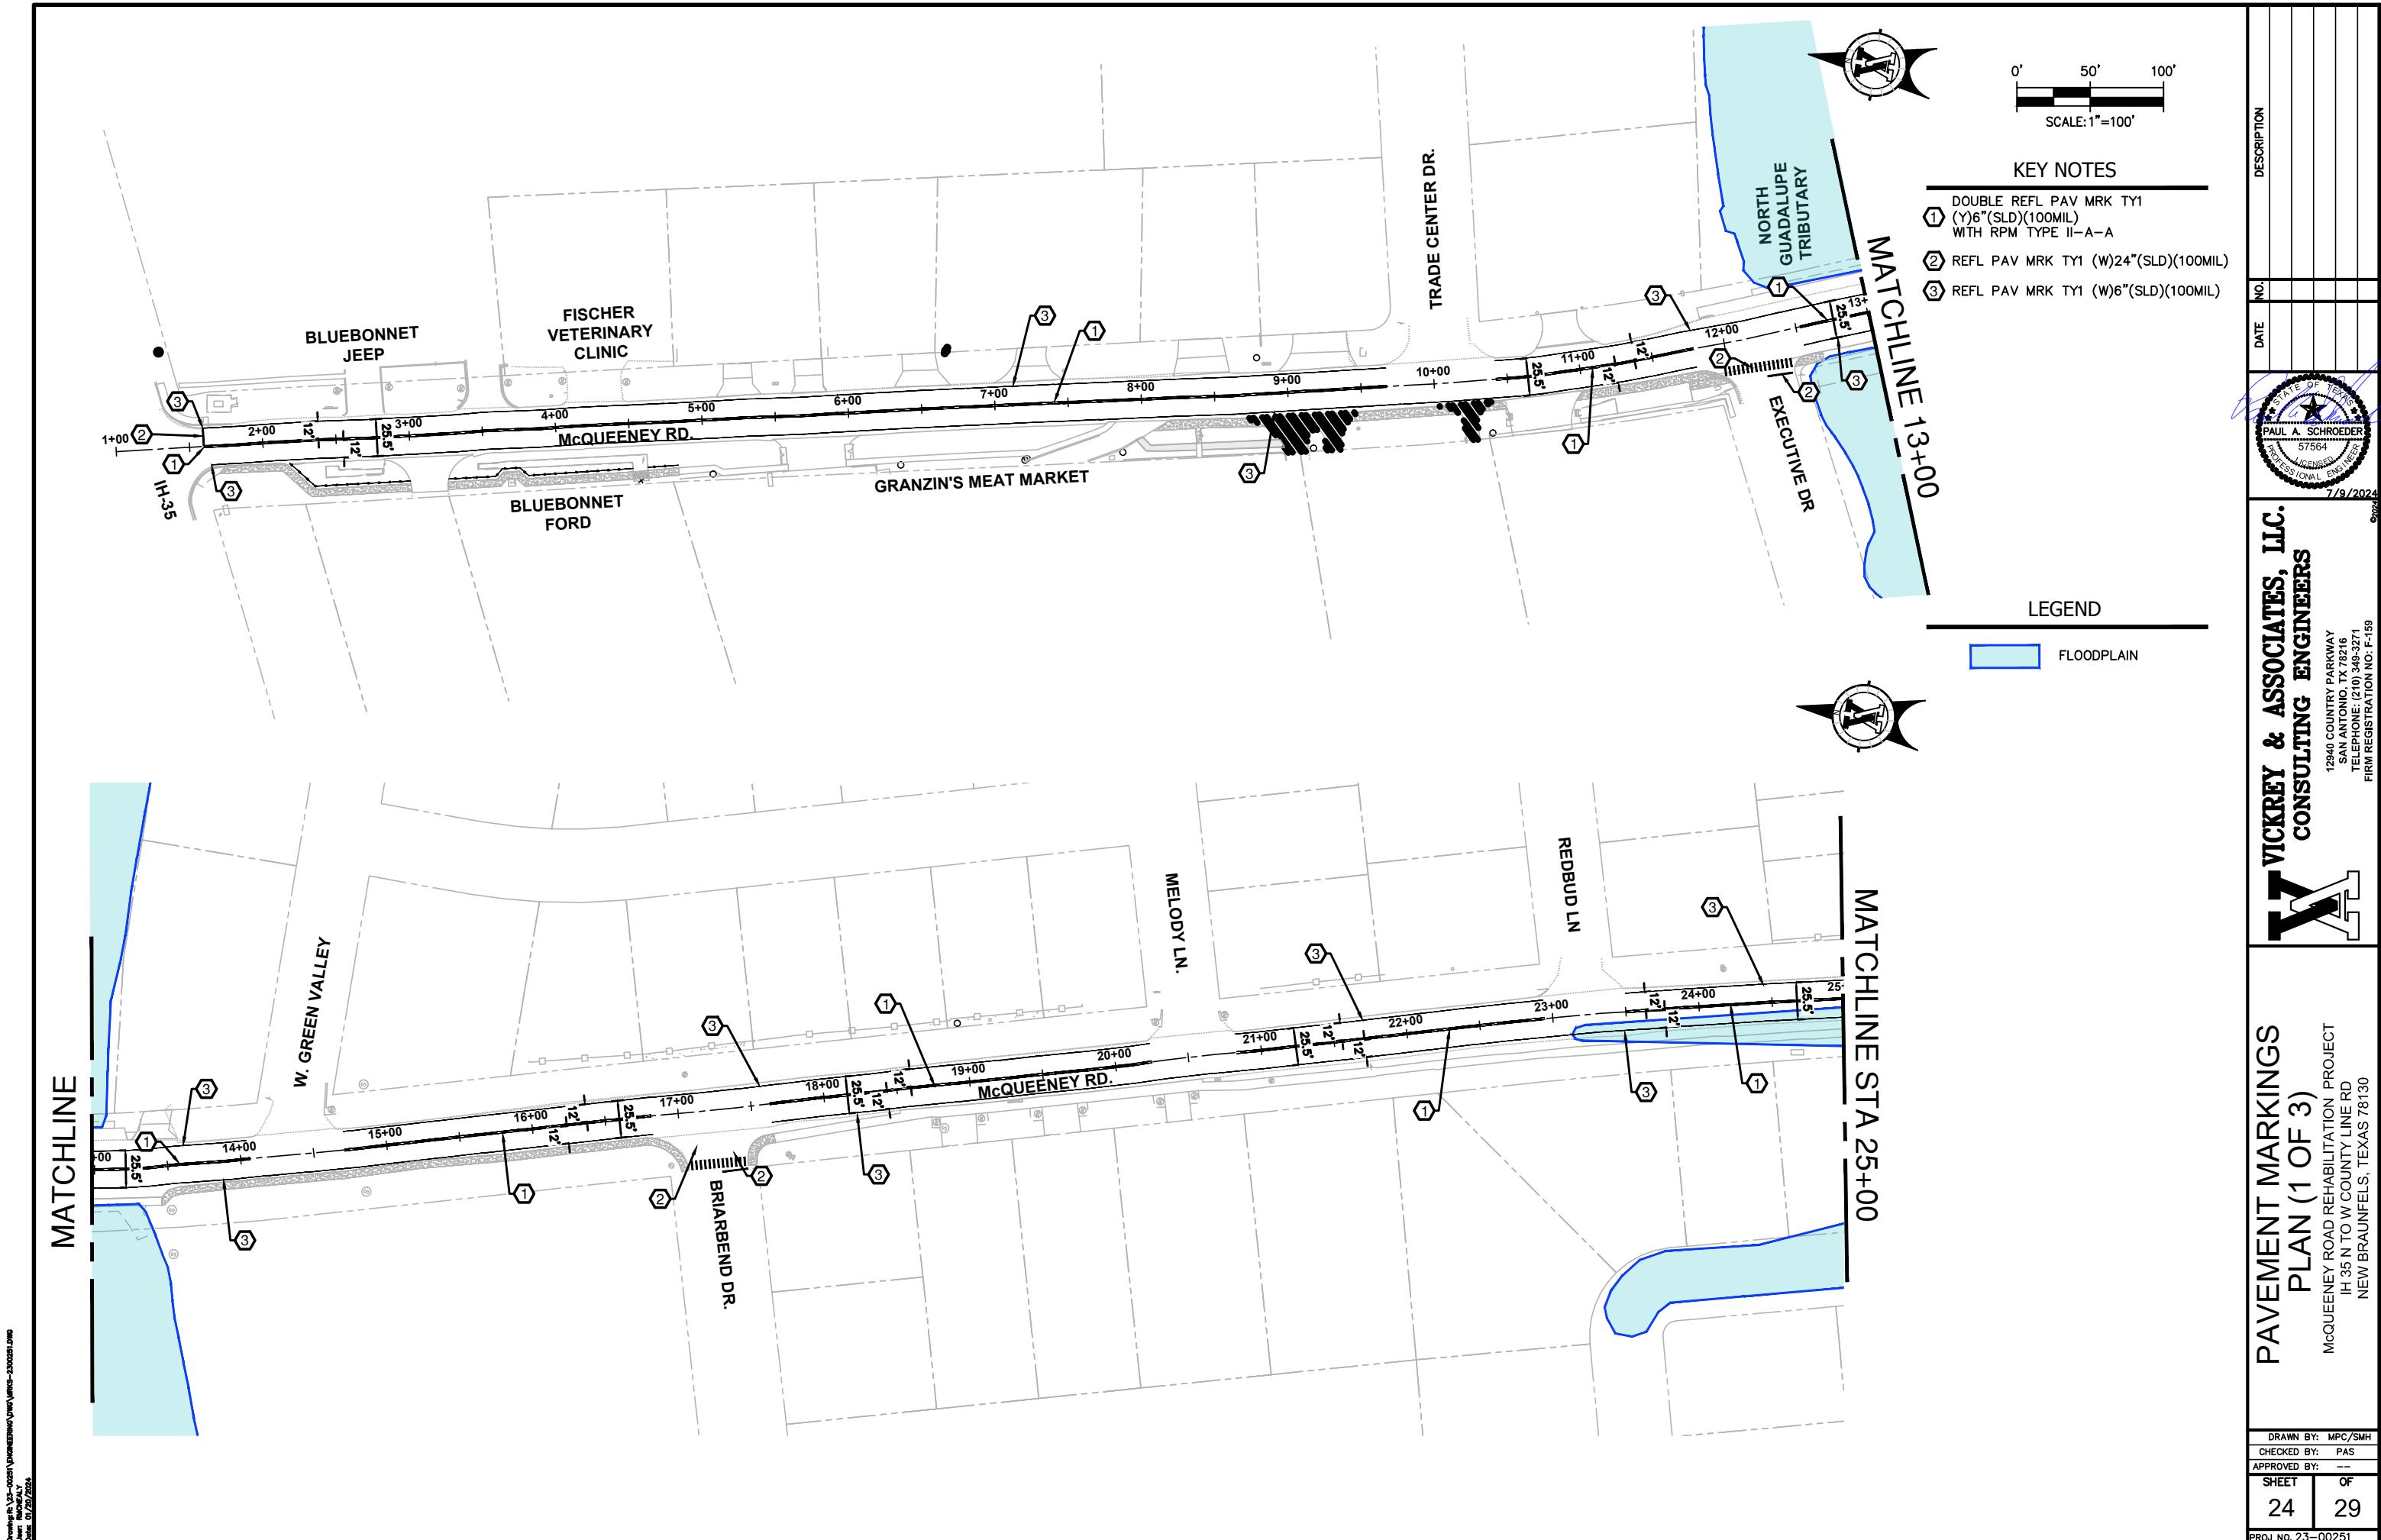

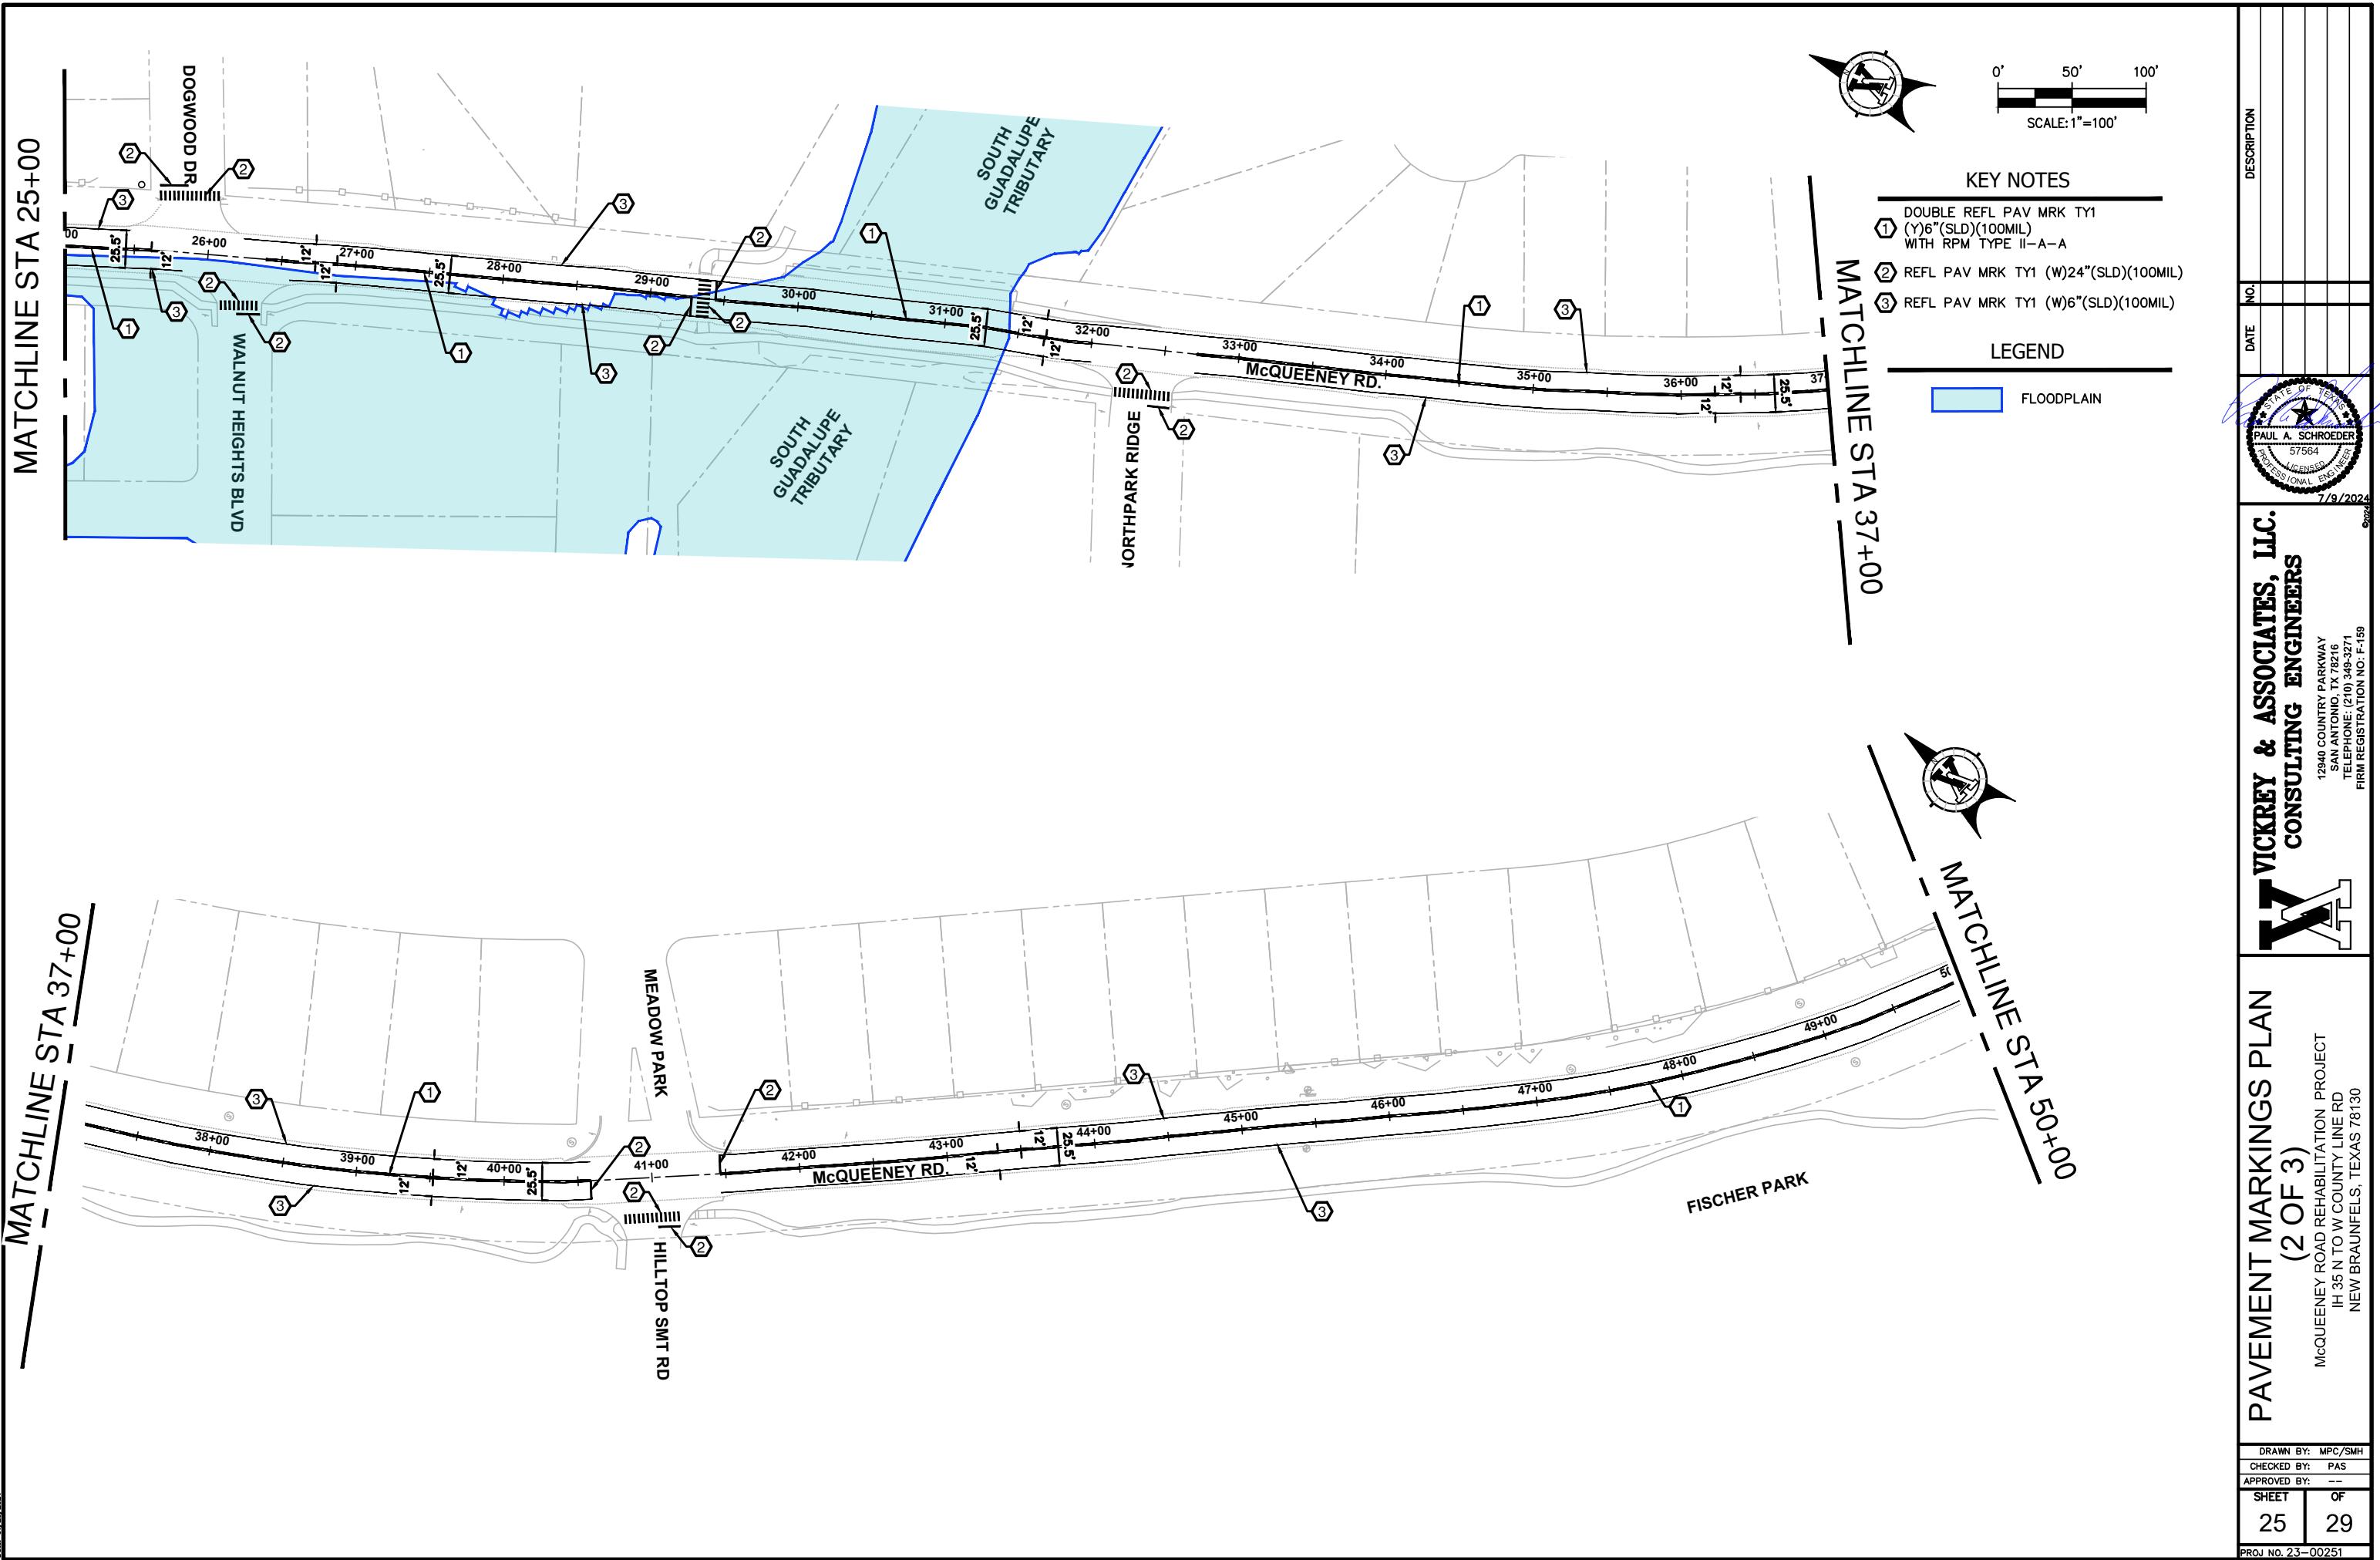


0' 50' 100'  
SCALE: 1"=100'



#### KEY NOTES

- ① DOUBLE REFL PAV MRK TY1 (Y)6"(SLD)(100MIL) WITH RPM TYPE II-A-A
- ② REFL PAV MRK TY1 (W)24"(SLD)(100MIL)
- ③ REFL PAV MRK TY1 (W)6"(SLD)(100MIL)

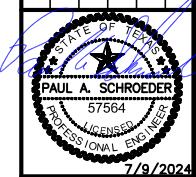

**VICKREY & ASSOCIATES, LLC.**  
**CONSULTING ENGINEERS**

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SAN ANTONIO, TX 78216  
TELEPHONE: (210) 349-3271  
FIRM REGISTRATION NO: F-159


**PAVEMENT MARKINGS PLAN**  
**(3 OF 3)**

McQUEENEY ROAD REHABILITATION PROJECT  
IH 35 N TO W COUNTY LINE RD  
NEW BRAUNFELS, TEXAS 78130

DRAWN BY: MPC/SMH	CHECKED BY: PAS
APPROVED BY: ---	
SHEET 26	OF 29

PROJ. NO. 23-00251

MATCHLINE STA 50+00

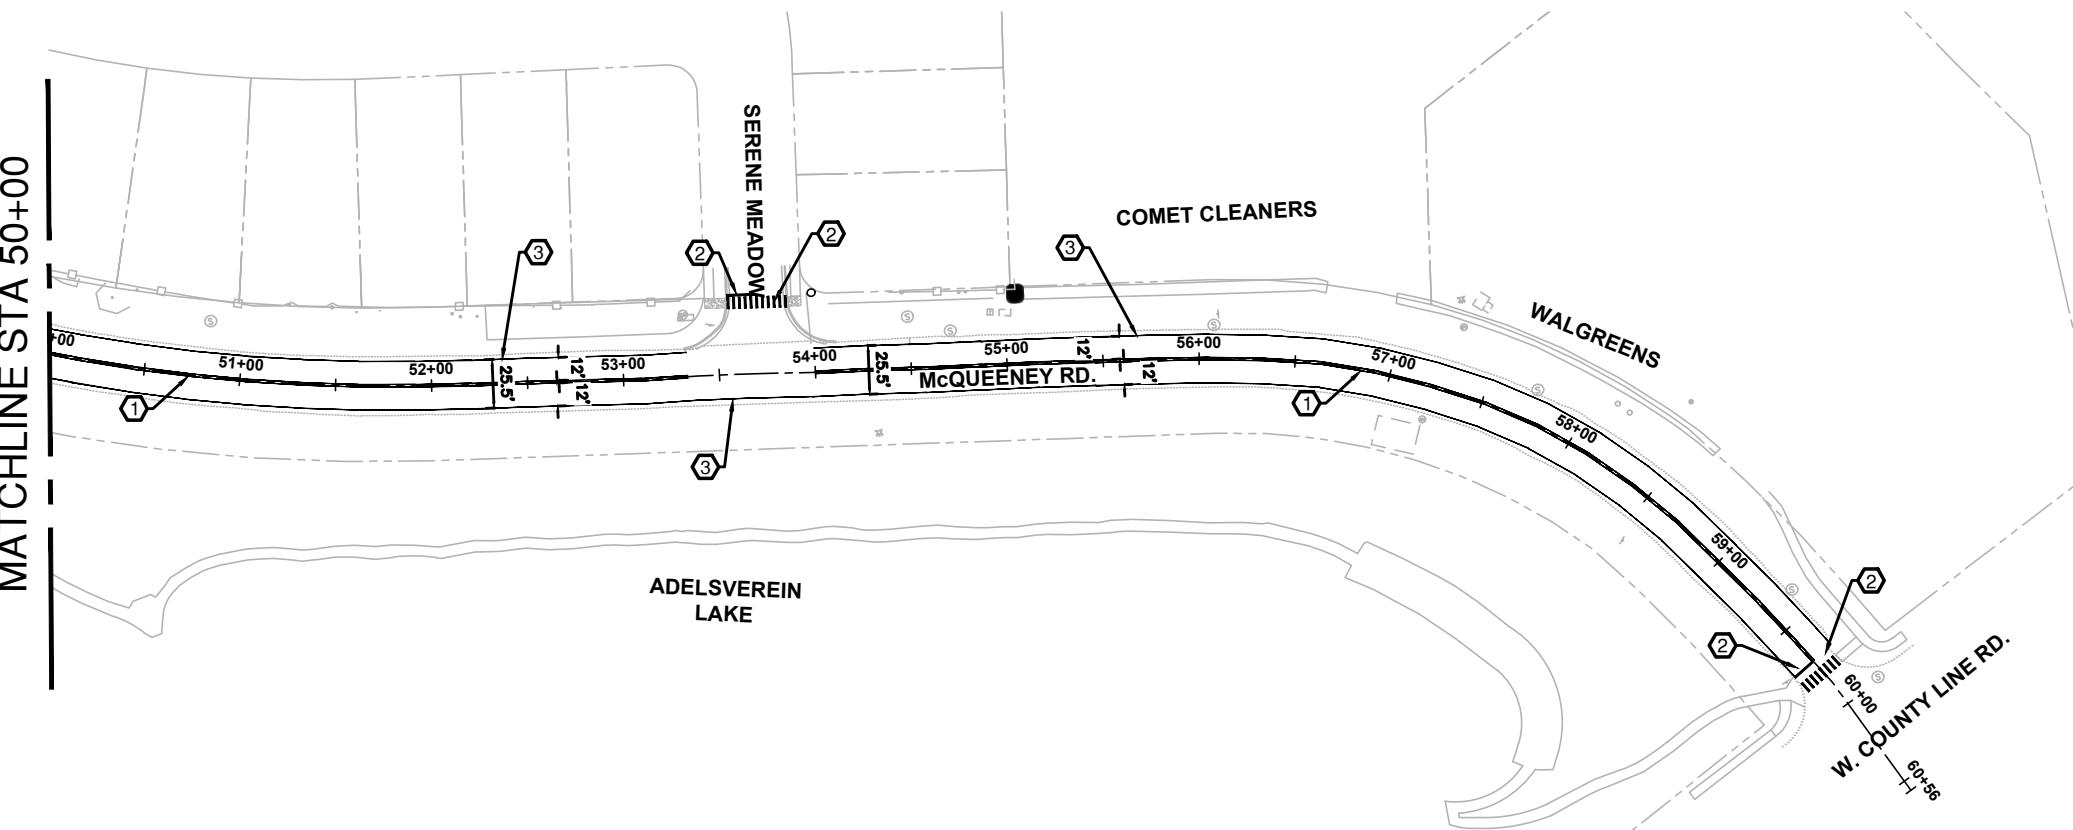

This sheet of this standard is governed by the Texas Engineering Practice Act. No authority of any kind is granted to any person to interpret or to construe any of the provisions of this standard. Any such interpretation or construction shall be made by the Texas Department of Transportation.

**EDGES, LINES, AND LANE LINES**

**EDGE LINE AND LANE LINES  
ONE-WAY ROADWAY  
WITH OR WITHOUT SHOULDERS**

**CENTERLINE AND LANE LINES  
FOUR LANE TWO-WAY ROADWAY  
WITH OR WITHOUT SHOULDERS**

**TWO LANE TWO-WAY ROADWAY  
WITH OR WITHOUT SHOULDERS**

**FOUR LANE DIVIDED ROADWAY CROSSOVERS**

**PUBLIC ROADWAY**

**ALLEY, PRIVATE ROAD OR MINOR DRIVEWAY**

**MAJOR DRIVEWAY**

**TYPICAL TWO-LANE, TWO-WAY PAVEMENT MARKINGS THROUGH INTERSECTIONS**

**DETAIL "A"**

**DETAIL "B"**

**PUBLIC ROADWAY**

**ALLEY, PRIVATE ROAD OR MINOR DRIVEWAY**

**MAJOR DRIVEWAY**

**TYPICAL MULTI-LANE, TWO-WAY PAVEMENT MARKINGS THROUGH INTERSECTIONS**

**DETAIL "B"**

**YIELD LINES**

**STOP LINES**

**EDGE LINE**

**CENTERLINE**

**YIELD LINES**

**STOP LINES**

**MINIMUM REQUIREMENTS FOR STOP LINES**

**MINIMUM REQUIREMENTS FOR CENTERLINES WITHOUT MEDIAN**

**MINIMUM REQUIREMENTS FOR CENTERLINES WITH MEDIAN**

**NOTES**

- Where divided highways are separated by median widths of thirty feet or more, median openings shall be signed as two separate controlled approaches. Each median opening has two width measurements, with one measurement for each approach. The narrow median width will be the controlling width to determine if signs are required, unless the typical intersection control, Stop signs and stop bars are optional as determined by the Engineer.
- Install median striping (double yellow centerlines and stop lines/yield lines) when 50' or greater median centerline can be placed. Stop lines shall only be used with yield signs.
- Length of turn bays, including taper, deceleration, and storage lengths shall be as shown on the plans or as directed by the Engineer.

**GENERAL NOTES**

- Edge line striping shall be as shown in the plans or as directed by the Engineer. The edge line striping may be placed within 6' inches from the center of the roadway. This distance may vary due to pavement roving or other conditions. Edge lines are not required in curb and gutter sections of roadway.
- The traveled way includes only that portion of the roadway used for vehicular travel. It does not include the parking lanes, sidewalks, berms or shoulders. The traveled ways shall be measured from the center of edge line to the center of edge line of a two lane roadway.

**MATERIAL SPECIFICATIONS**

PAVEMENT MARKERS (REFLECTIVE)	DMS-4200
EPoxy and Adhesives	DMS-6100
BITUMINOUS ADHESIVE FOR PAVEMENT MARKERS	DMS-6130
TRAFFIC PAINT	DMS-6200
HOT APPLIED THERMOPLASTIC	DMS-6220
PERMANENT PREFABRICATED PAVEMENT MARKINGS	DMS-6240

All pavement marking materials shall meet the requirements of Departmental Material Specifications as specified by the plans.

**GUIDE FOR PLACEMENT OF STOP LINES, EDGE LINE & CENTERLINE**

Based on Traveler Way and Pavement Widths for Undivided Highways

**Texas Department of Transportation**

**Traffic Safety Division**

**TYPICAL STANDARD PAVEMENT MARKINGS**

**PM(1)-22**

DISCLAIMER:  
The use of this standard is governed by the Texas Department of Transportation's Uniformity of Engineering Practice Act. Noncompliance with this standard to other formats may result in damage resulting from its use.

**CENTERLINE BUFFER FOR MULTI-LANE UNDIVIDED ROADWAYS**  
FOR BUFFER WIDTHS OF 24 INCHES(a) OR 30 INCHES(b)

**WIDE CENTERLINE BUFFER FOR MULTI-LANE UNDIVIDED ROADWAYS**  
FOR BUFFER WIDTHS OF 36 INCHES(c), 42 INCHES(d) OR 48 INCHES(e)

DETAIL "A"

DETAIL "B"

## GENERAL NOTES:

1. A buffer shall not be implemented if it will require reducing the width of inside travel lanes to be less than 12 feet.
2. See standard sheet PM(2) for additional details regarding retroreflectorized raised pavement markers (RPMs).
3. This sheet shows the application of milled rumble strips, though other types may be used. See the Rumble Strip (RS) standard for installation details.
4. Dimension notations (a) through (e) correspond to the following buffer widths: a = 24 inches; b = 30 inches; c = 36 inches; d = 42 inches; and e = 48 inches.
5. The Engineering and Construction of Bicycle Facilities during the Planning and Implementation of All Construction and Rehabilitation Projects. See standard sheet R5(6) and the TxDOT Roadway Design Manual (RDM) Bicycle Facilities section for applicable policies, references and guidance.

## MATERIAL SPECIFICATIONS

Pavement Markers (Reflectorized)	DMS-4200
Epoxyres and Adhesives	DMS-4100
Bituminous Adhesive for Pavement Markers	DMS-4130
Traffic Paint	DMS-4200
Hot Applied Thermoplastic	DMS-4220
Permanent Prefabricated Pavement Markings	DMS-6240

All pavement marking materials shall meet the required Departmental Material Specifications.

Traffic Safety Division Standard

## CENTERLINE BUFFER MULTI-LANE ROADWAYS

**CLB(1)-23**

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**KIRK & ASSOCIATES, LLC.**  
CONSULTING ENGINEERS

12940 COUNTRY PARKWAY  
SAN ANTONIO, TX 78216  
TELEPHONE: (210) 349-3271  
FIRM REGISTRATION NO. F-159

McQUEENEY ROAD REHABILITATION PROJECT  
IH 35 N TO W COUNTY LINE RD  
NEW BRAUNFELS, TEXAS 78130

McQUEENEY ROAD REHABILITATION PROJECT  
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NEW BRAUNFELS, TEXAS 78130

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